NEW SINGLE FAMILY HOME

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PROJECT LOCATION

KEVIN HACKETT AND AMY JAMES
72 DOUGLAS RD
MINERAL VA 23117
MINERAL VA 23117
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DESIGNER OF RECORD

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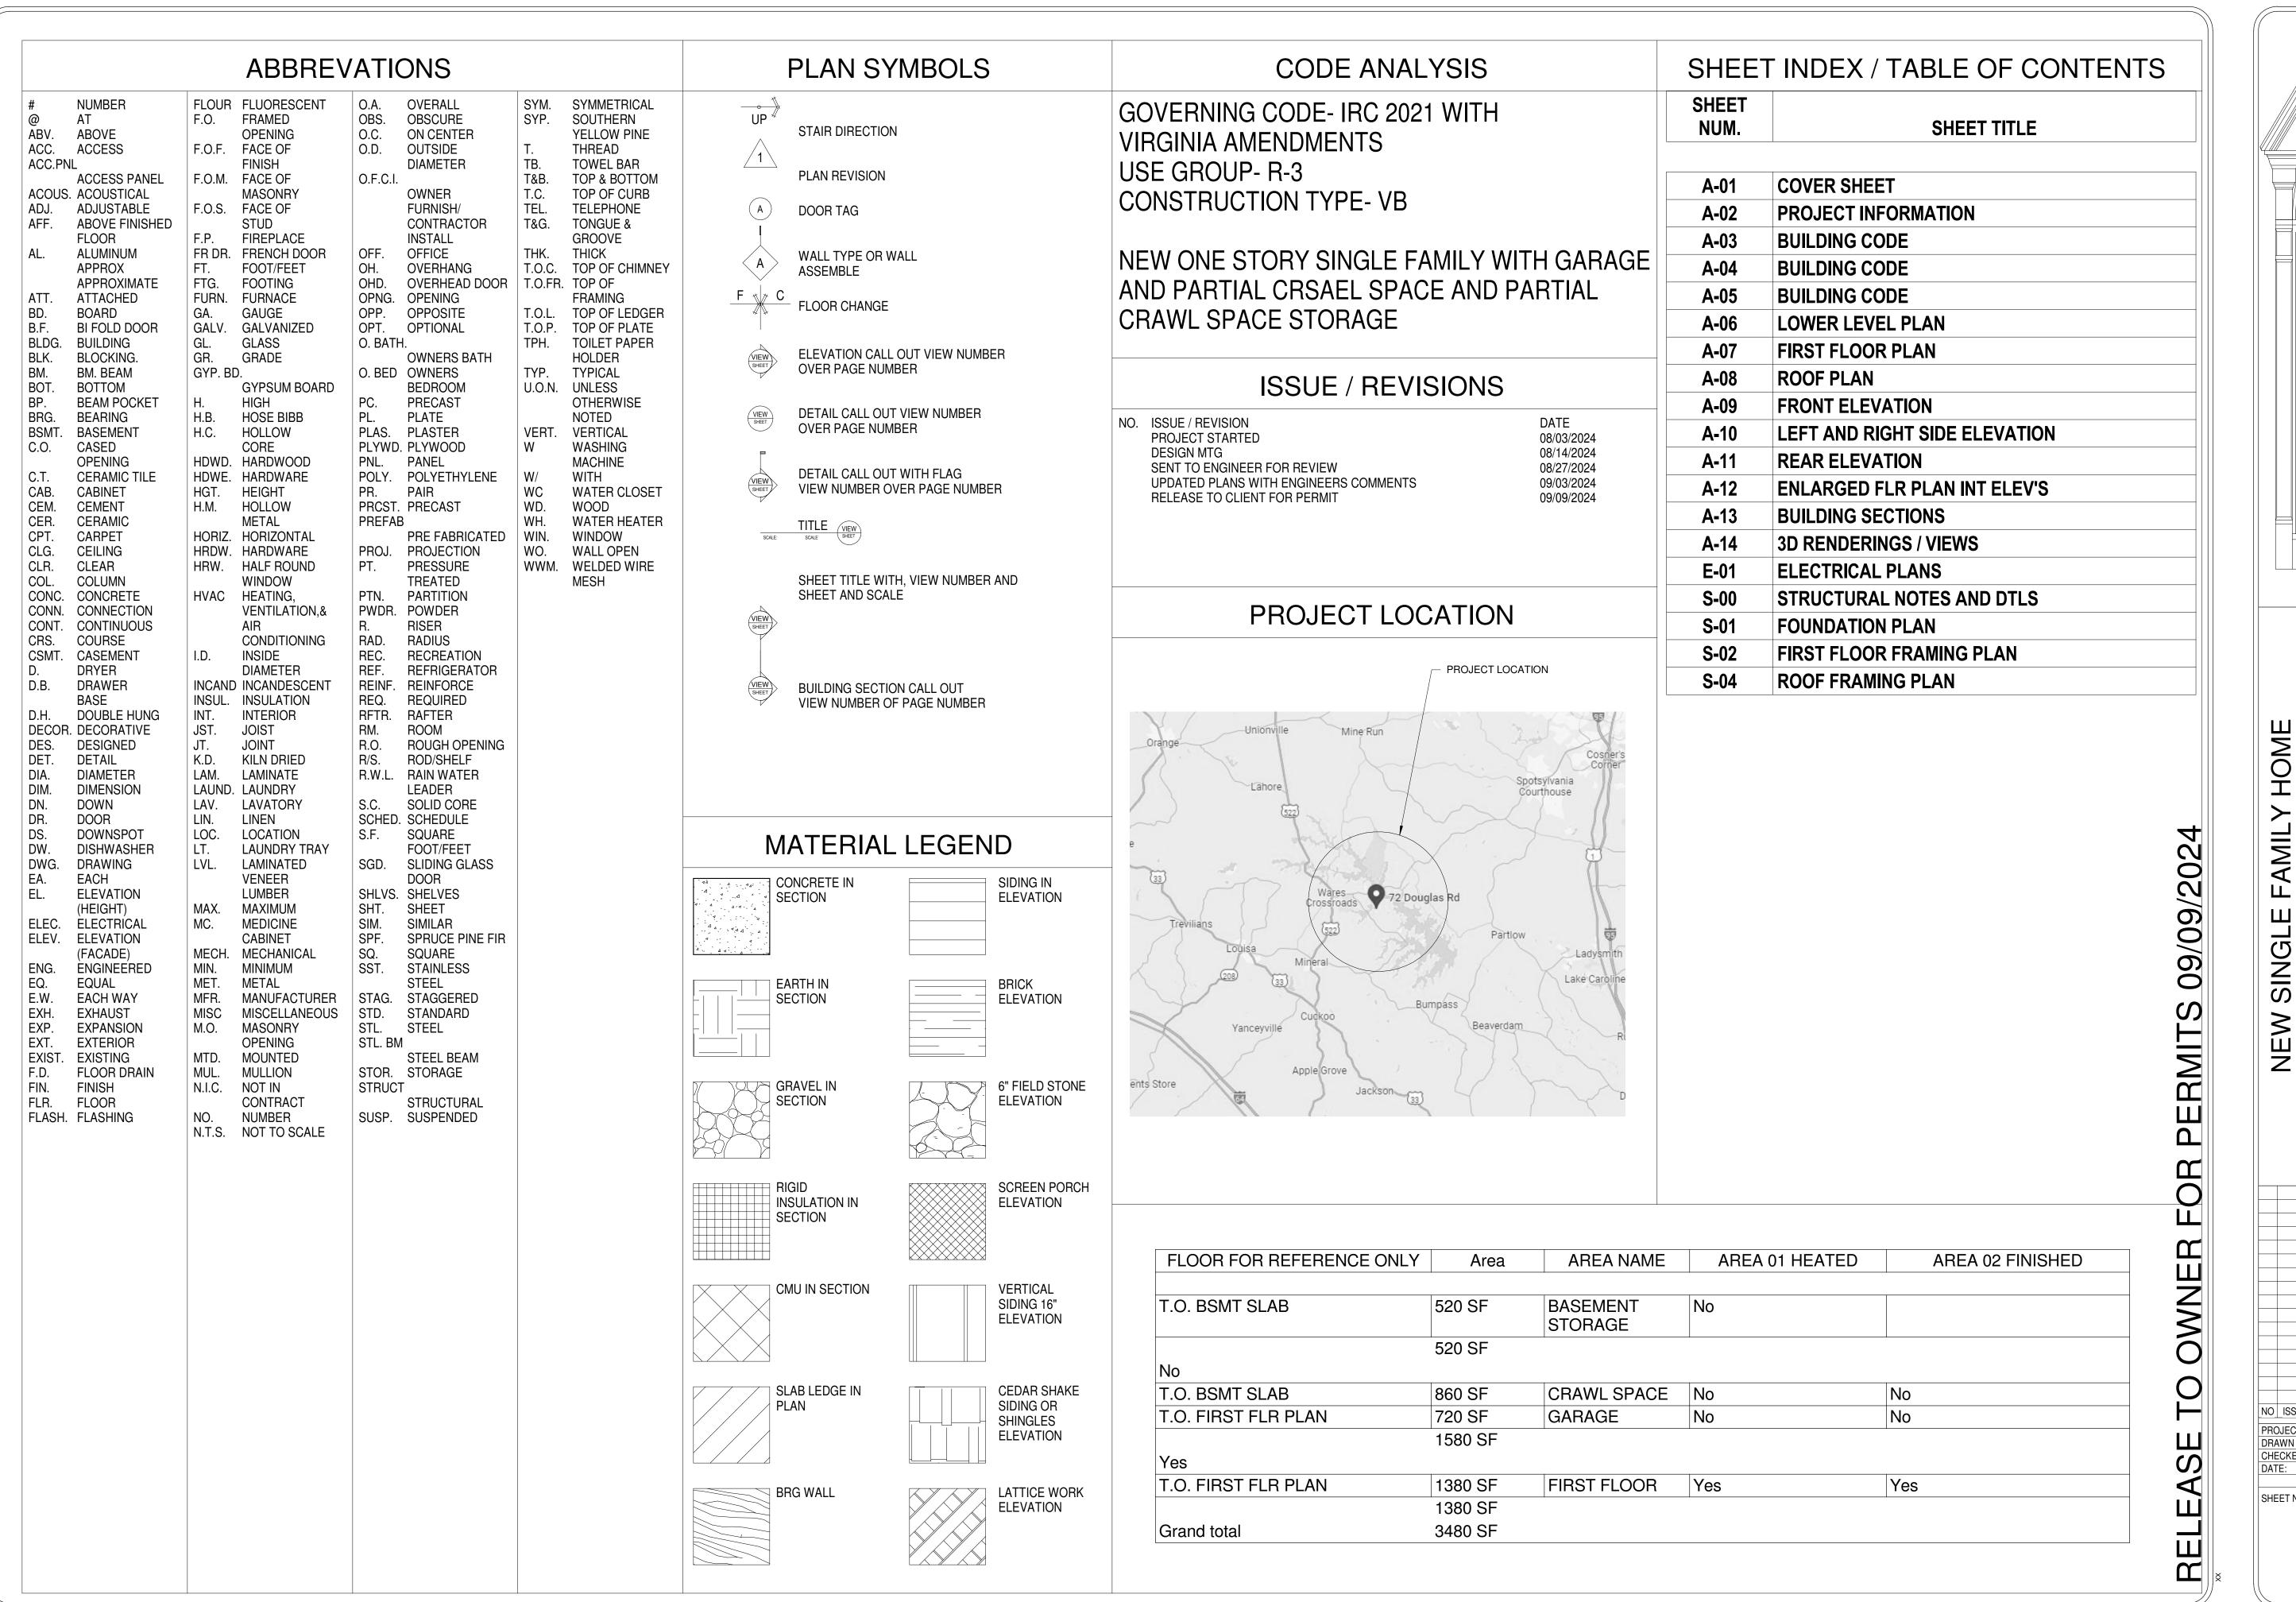
BUILDER / CONTRACTOR

TBD

		DESIGN AND DRAFTING SERVICES	WOODSTOCK, VA PH 540.514.2643
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RELEASE TO OWNER FOR PERMITS 09/09/2024



DESIGN AND DRAFTING SERVICES

WOODSTOCK, VA PH 540.514.2643

72 DOUGLAS RD, MINERAL VA 23117 PROJECT INFORMATION

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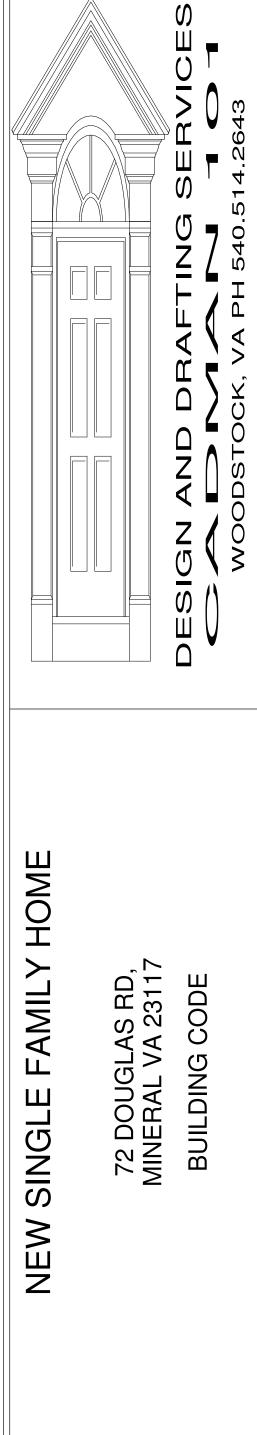
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- IRC 2021 SPECIFICATIONS
- 1. GENERAL: THE WORK SHALL COMPLY WITH ALL APPLICABLE LOCAL AND STATE CODES, ORDINANCES, REGULATIONS AND AMENDMENTS AND ALL OTHER AUTHORITIES HAVING JURISDICTION. THE WORK SHALL COMPLY WITH INTERPRETATIONS OF THE LOCAL BUILDING OFFICIAL. IF THE INTERPRETATION OF THE LOCAL BUILDING OFFICIAL IS AT VARIANCE WITH THESE DOCUMENTS, INFORM THE ARCHITECT PRIOR TO PROCEEDING.
- 2. CONSTRUCTION METHODS AND TECHNIQUES THE ARCHITECT IS NOT RESPONSIBLE FOR CONSTRUCTION MEANS, METHODS, TECHNIQUES, PROCEDURES, OR FOR SAFETY MEASURES IN CONNECTION WITH THE WORK AND SHALL NOT BE HELD RESPONSIBLE FOR THE CONTRACTORS, SUBCONTRACTORS OR ANYONE PERFORMING THE WORK, TO CARRY OUT THE WORK IN ACCORDANCE WITH THE CONTRACT DOCUMENTS.
- 3. FIELD CONDITIONS AND DIMENSIONS ON-SITE VERIFICATION OF ALL DIMENSIONS AND CONDITIONS SHALL BE THE RESPONSIBILITY OF THE GENERAL CONTRACTOR AND HIS SUBCONTRACTORS. NOTED DIMENSIONS TAKE PRECEDENCE OVER SCALED DIMENSIONS. ARCHITECT SHALL BE NOTIFIED PROMPTLY OF ANY DISCREPANCIES IN INFORMATION AND OF ANY DISCREPANCIES BETWEEN FIELD CONDITIONS AND INFORMATION ON THE DRAWINGS PRIOR TO CONSTRUCTION.
- 4. TYPICAL CONDITIONS THE GENERAL NOTES AND TYPICAL DETAILS APPLY THROUGHOUT THE JOB UNLESS INDICATED OTHERWISE. WHERE CONDITIONS ARE NOT SPECIFICALLY SHOWN OR DETAILED, THE CHARACTER AND QUALITY OF THE WORK SHALL BE THE SAME AS THAT INDICATED FOR SIMILAR CONDITIONS.
- 5. COORDINATION OF WORK THE CONTRACTOR SHALL COORDINATE AND COMPARE ALL DRAWINGS BETWEEN THE DIFFERENT CONSULTANTS AND TRADES AND SHALL PROMPTLY NOTIFY THE ARCHITECT OF ANY DISCREPANCIES THAT MAY BE FOUND.
- 6. STRUCTURAL NOTES IN CASE OF ANY DISCREPANCIES BETWEEN THESE NOTES AND NOTES ON THE STRUCTURAL DRAWINGS, THE NOTES FOUND ON THE STRUCTURAL DRAWINGS SHALL TAKE PRECEDENCE.
- 7. TEMPORARY BRACING USE TEMPORARY BRACING AS REQUIRED TO STABILIZE BASEMENT AND FOUNDATION WALLS AND SUPERSTRUCTURE UNTIL PERMANENT CONSTRUCTION IS IN PLACE
- 7.1. THE STRUCTURAL INTEGRITY OF THE BUILDING IS DEPENDENT UPON COMPLETION ACCORDING TO PLANS AND SPECIFICATIONS. THE ARCHITECT AND STRUCTURAL ENGINEERS ASSUME NO LIABILITY FOR THE STRUCTURE DURING CONSTRUCTION. THE METHOD OF CONSTRUCTION AND SEQUENCE OF OPERATIONS IS THE SOLE RESPONSIBILITY OF THE CONTRACTOR. THE CONTRACTOR SHALL SUPPLY ANY NECESSARY SHORING, BRACING, STRUTS, GUYS, ETC. TO PROPERLY BRACE THE STRUCTURE AGAINST WIND, DEAD AND LIVE LOADS UNTIL THE BUILDING IS COMPLETED ACCORDING TO THE PLANS AND SPECIFICATIONS. CONTRACTOR SHALL NOT PLACE BACK-FILL AGAINST BASEMENT WALLS UNTIL THE FLOOR SYSTEM IS COMPLETELY INSTALLED OR CONTRACTOR HAS

- PROVIDED ADEQUATE SHORING AND BRACING. ANY QUESTIONS REGARDING TEMPORARY BRACING REQUIREMENTS SHOULD BE FORWARDED TO A STRUCTURAL ENGINEER FOR REVIEW.
- 8. DESIGN LOADS: SEE STRUCTURAL DRAWINGS FOR SPECIFICATIONS
- 9. MECHANICAL UNITS AND ANY OTHER EQUIPMENT SUPPORTED BY THE STRUCTURE WITH WEIGHTS IN EXCESS OF 200 POUNDS SHALL BE BROUGHT TO THE ATTENTION OF THE STRUCTURAL ENGINEER PRIOR TO INSTALLATION.
- 10. PRODUCT LITERATURE AND MANUFACTURER'S RECOMMENDATIONS COMPLY WITH THE MANUFACTURER'S OR FABRICATOR'S INSTRUCTIONS OR RECOMMENDATIONS FOR THE PREPARATION OF SUBSTRATES AND INSTALLATION AND USE OF MATERIAL..
- 11. FIRE RATED ASSEMBLIES IT IS THE RESPONSIBILITY OF THE GENERAL CONTRACTOR AND HIS SUBCONTRACTORS TO VERIFY AND CONSTRUCT ALL RATED ASSEMBLIES TO COMPLY EXACTLY WITH THE REQUIREMENTS OF THE TEST REPORTS LISTED. THE ARCHITECT SHALL BE NOTIFIED PROMPTLY OF ANY CHANGE IN MATERIALS PRIOR TO CONSTRUCTION AND PROMPTLY OF ANY CHANGE IN MATERIALS PRIOR TO CONSTRUCTION AND ANY CHANGES IN MATERIALS MUST HAVE THE PRIOR APPROVAL
- OF THE ARCHITECT. ALL FIRE RATED ASSEMBLIES ARE CONTINUOUS UNLESS OTHERWISE NOTED. ASSEMBLY MATERIALS SHALL TAKE PRECEDENCE OVER MATERIALS SPECIFIED IN THESE DRAWINGS.
- 12. RADON TESTING CONTRACTOR TO INVESTIGATE SITE AND CONDUCT NECESSARY TEST TO INSURE THAT RADON GAS DOES NOT EXCEED SAFE LIMITS AS MANDATED BY STATE OR LOCAL LAWS. NOTIFY ARCHITECT AND LOCAL
- JURISDICTIONAL AUTHORITIES BEFORE BEGINNING CONSTRUCTION FOR SPECIFIC DETAILS WHICH MAY BE REQUIRED.
- 13. MECHANICAL / PLUMBING / ELECTRICAL CONTRACTORS SHALL BE REQUIRED TO SEAL ALL HORIZONTAL AND VERTICAL PENETRATIONS IN THE EXTERIOR WALL CAUSED BY THEIR TRADE.
- 14. ALL SHEATHING PENETRATIONS CAUSED BY ERECTION SHALL BE PATCHED AND REPAIRED ACCORDING TO MANUFACTURER'S SPECIFICATIONS.
- 15. DETAILS OF CONSTRUCTION OF ANY RETAINING WALL BUILT MUST BE SUBMITTED TO THE OFFICE OF THE BUILDING INSPECTOR FOR APPROVAL PRIOR TO CONSTRUCTION.
- 16. GENERAL CONTRACTOR IS RESPONSIBLE TO LOCATE AND PROVIDE NECESSARY STRUCTURAL, MECHANICAL, ELECTRICAL AND PLUMBING SLEEVES, ANCHORS, VENT OPENING, ETC THAT MIGHT BE REQUIRED.
- 17. SITE WORK
- 17.1. THESE DRAWINGS DO NOT COVER SITE WORK, EXCAVATION, GRADING AND LANDSCAPING. REFER TO THE SITE DRAWINGS PREPARED BY THE CIVIL ENGINEER FOR THESE ITEMS.

- 17.2. EXCAVATION SHALL BE SUFFICIENT TO PROVIDE FULL DESIGN DIMENSIONS OR TO ALLOW FOR FORMING AS REQUIRED. NO FOOTINGS SHALL BE PLACED ON FROZEN EARTH. NO FOOTING SHALL BE PLACED ON SOFT MATERIAL.
- 17.3. BACKFILL AND COMPACTION USE ONLY CLEAN, WELL GRADED EARTH CONTAINING NO ORGANIC MATERIAL, TRASH, MUCK, ROOTS, LOGS, STUMPS, CONCRETE, ASPHALT, OR OTHER DELETERIOUS SUBSTANCES. BACKFILL SHALL BE COMPACTED TO 95% OF MAXIMUM DENSITY AS DETERMINED BY THE ASTM D698 STANDARD PROCTOR TEST. DO NOT BACKFILL AGAINST BASEMENT WALLS UNTIL SUPER STRUCTURE IS IN PLACE. PRIOR TO PLACING FILL, THE EXISTING SURFACE SHALL BE CLEARED OF ALL REFUSE OR ORGANIC MATERIALS. BACKFILL IN LAYERS OF 6"-8" EACH. ALL SOIL FILL MATERIAL MUST BE APPROVED BY SOILS ENGINEER PRIOR TO PLACEMENT.
- 18. CONCRETE/FOUNDATIONS ALL REINFORCED CONCRETE TO BE IN ACCORDANCE WITH THE AMERICAN CONCRETE INSTITUTE ACI 318-99. SEE STRUCTURAL DRAWINGS FOR ADDITIONAL SPECIFICATIONS
- 19. REINFORCING: SEE STRUCTURAL DRAWINGS FOR SPECIFICATIONS
- 20. SLABS ON GRADE: SEE STRUCTURAL DRAWINGS FOR SPECIFICATIONS
- 21. MASONRY: SEE STRUCTURAL DRAWINGS FOR SPECIFICATIONS
- 22. METALS: SEE STRUCTURAL DRAWINGS FOR SPECIFICATIONS
- 23. WOODS: SEE STRUCTURAL DRAWINGS FOR SPECIFICATIONS
- 24. FIRE RETARDANT TREATED PLYWOOD AND DIMENSIONAL LUMBER (WHERE APPLICABLE)-IF FIRE RETARDANT TREATED PLYWOOD IS APPLIED TO A STRUCTURE, (FIRE RETARDANT PLYWOOD MUST BE APPLIED 4' TO EITHER SIDE OF FIRE WALLS OR PARTY WALLS UNLESS NOTED OTHERWISE) IT IS TO BE ACCOMPANIED BY VERIFICATION THAT ACID HYDROLYSIS WILL NOT OCCUR IN THE PRODUCT AT TEMPERATURES BELOW 400 DEGREES FAHRENHEIT; THIS CERTIFICATION MUST COME FROM THE MANUFACTURER AND BE APPROVED BY A CERTIFIED TESTING AGENCY AND LOCAL BUILDING OFFICIALS.
- 25. INTERIOR TRIM WINDOWS, DOOR AND BASES MAY BE FINGER JOINTED, 2 1/2" TRADITIONAL PROFILE OR AS INDICATED ON DRAWINGS.
- 26. INTERIOR STAIRS PRE-FABRICATED WOOD UNLESS OTHERWISE NOTED
- 27. SHELVING 3/4" FILLED FLAKEBOARD WITH TAPERED FRONT EDGE, SHOP AND METAL BRACKETS, 42" O/C MAX., UNLESS INDICATED OTHERWISE ON DRAWINGS OR VINYL WRAP WIRE SHELVING AS SELECTED BY BUILDER (OWNER).
- 28. HANDRAILS SHALL BE PROVIDED ON AT LEAST ONE SIDE OF EACH CONTINUOUS RUN OF TREADS OR FLIGHT WITH FOUR OR MORE RISERS.

- 29. HANDRAIL HEIGHT IS TO BE MEASURED VERTICALLY FROM THE SLOPED PLANE ADJOINING THE TREAD NOSING, OR FINISH SURFACE OF RAMP SLOPE, SHALL BE NOT LESS THAN 34" AND NOT MORE THAN 38"
- 30. HANDRAIL GRIP SIZE:
- 30.1. CIRCULAR CROSS SECTION SHALL HAVE AN OUTSIDE DIAMETER OF 1 1/4"-2". IF NOT CIRCULAR IT SHALL HAVE A PERIMETER DIMENSION BETWEEN 4" 6 1/4" WITH A MAX CROSS SECTION OF 2 1/4".
- 30.2. PERIMETER GREATER THAN 6 1/4" SHALL HAVE A GRASPABLE FINGER RECESS AREA. MINIMUM WIDTH ABOVE RECESS TO BE 1 1/4"-2 3/4".
- 31. GUARD RAILS- PORCHES, BALCONIES, RAMPS OR RAISED FLOOR SURFACES LOCATED MORE THAN 30" ABOVE THE FLOOR OR GRADE BELOW SHALL HAVE GUARDS NOT LESS THAN 36" IN HEIGHT AND NOT ALLOW PASSAGE OF A SPHERE 4"Ø.
- 32. THERMAL AND MOISTURE PROTECTION
- 32.1. SILL SEAL FIBROUS POLY SILL SEALER BENEATH ALL EXTERIOR SILL PLATES.
- 32.2. A. WALLS R-15 MINIMUM 3 5/8" BATT INSULATION WITH KRAFT PAPER FACE VAPOR BARRIER, UNLESS OTHERWISE NOTED. PROVIDE 3 1/2" R-15 BLANKET INSULATION IN ALL EXTERIOR FRAME WALLS THAT ARE 4" THICK. PROVIDE 6" R-19 BLANKET INSULATION IN ALL 6" EXTERIOR FRAME WALLS, AND ANY FLOOR AREA EXPOSED TO THE ELEMENTS OR BELOW STORAGE ROOM. PROVIDE R-13 BATT INSULATION OR SPRAY FOAM IN ALL FURRED OUT BASEMENT WALLS.
- 32.3. CEILINGS AT ROOF R-38 FIBERGLASS BATT WITH KRAFT PAPER FACE VAPOR BARRIER, OR BLOW INSUL. WITH R-38 MIN.
- 32.4. CRAWL SPACES AND OTHER FLOORS EXPOSED TO UNHEATED SPACES BELOW, R-19 FIBERGLASS BATT WITH KRAFT PAPER FACE VAPOR BARRIER.
- 32.5. BUILDING WRAP IN MIXED-HUMID CLIMATES (ZONE 4) INSTALL BUILDING WRAP ON EXTERIOR FACE, LAPPED AND SEALED PER MFR., UNLESS NOTED OTHERWISE ON DRAWINGS.
- 32.6. FOAM PLASTIC / INSULATION SHALL COMPLY WITH THE FLAME SPREAD AND SMOKE DEVELOPED REQUIREMENTS.
 33. ROOFING
- 33.1. SHINGLES 235# ASPHALT OR 215# FIBERGLASS SHINGLES CLASS 'C' OR BETTER ON 15# ROOFING FELT ON SLOPES OF 4" TO 12" OR GREATER. ON SLOPES LESS THAN 4" TO 12" BUT GREATER THAN 2" TO 12" PROVIDE DOUBLE COVERAGE ASPHALT/FIBERGLASS SHINGLES ON TWO LAYERS 15# ROOFING FELT. SHINGLES SHALL BE INSTALLED PER MANUFACTURER'S SPECIFICATIONS AND APPLICABLE BUILDING CODES.
- 33.2. VALLEY FLASHING OPEN VALLEYS SHALL BE FLASHED WITH MIN. NO. 28 GAUGE GALVANIZED CORROSION -RESISTANT SHEET METAL AND SHALL EXTEND MINIMUM 8" FROM CENTER LINE EACH WAY. CLOSED VALLEY FLASHING SHALL BE TWO LAYERS 90# MINERAL SURFACED



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- CAP SHEET WITH BOTTOM LAYER MINIMUM 12" WIDE AND TOP LAYER 24" WIDE, CEMENTED TOGETHER. CLOSED VALLEYS MAY ALSO BE OF 36" WIDE FOIL ROOFING MATERIAL NOT LESS THAN NO. 50 IN THE VALLEY OVER THE UNDERLAYMENT.
- 33.3. RIDGE FLASHING- INSTALL AS PER MANUFACTURER'S SPECIFICATIONS.
- 33.4. ROOF EDGE- PROVIDE NON-CORROSIVE ALUMINUM DRIP EDGE FLASHING AT ROOF EDGE.
- 33.5. BUILT UP ROOFING TO BE DETAILED ON DRAWINGS AND NSTALLED AS PER MANUFACTURER'S SPECIFICATIONS.
- 33.6. ROOFING AND SHEET METAL INSTALLATION SHALL BE IN ACCORDANCE WITH STANDARDS AND DETAILS ESTABLISHED BY THE SHEET METAL AND AIR CONDITIONING CONTRACTORS NATIONAL ASSOCIATION, INC. "SMACNA" REFER TO 4TH EDITION, 1987, FOR SPECIFIC DETAIL INFORMATION.
- 33.7. SINGLE PLY ROOFING E.P.D.M. SINGLE PLY ROOFING MEMBRANE .045 MIL OR BETTER TO BE INSTALLED PER MANUFACTURERS SPECIFICATIONS AND APPLICABLE BUILDING CODES.
- 33.8. SNOW GUARDS INSTALLATION SHALL BE IN ACCORDANCE WITH THE MANUFACTURERS STANDARDS AND RECOMMENDATIONS FOR QUANTITY, LOCATION AND SPACING.
- 33.9. PROVIDE ICE BARRIER THAT CONSISTS OF AT LEAST TWO LAYERS OF UNDERLAYMENT CEMENTED TOGETHER OR OF A SELF-ADHERING POLYMER MODIFED BITUMEN SHEET, SHALL BE USED IN LIEU OF NORMAL UNDERLAYMENT AND EXTEND FROM THE LOWEST EDGE OF ALL ROOF SURFACE TO A PONT AT LEAST 24 INCHES INSIDE THE EXTERIOR WALL LINE OF THE BUILDING.
- 34. EXTERIOR WALLS
- 34.1. FLASHING TO BE NON-CORROSIVE ALUMINUM OR COPPER PROVIDED AT TOPS AND SIDES OF ALL EXTERIOR WINDOW AND DOOR OPENINGS IN SUCH A MANNER TO BE LEAKPROOF REFER TO STANDARDS AND DETAILS ESTABLISHED BY THE SHEET METAL & AIR CONDITIONING CONTRACTORS NATIONAL ASSOCIATION, INC. "SMACNA", 4TH EDITION, 1987.
- 34.2. FLASH AND COUNTER FLASH ALL ROOF TO WALL CONDITIONS, MINIMUM NO. 26 GAUGE CORROSION RESISTANT ALUMINUM STEP FLASHING AS REQUIRED TO MAINTAIN MINIMUM HEIGHT. WHEN FLASHING AGAINST MASONRY, FLASHING SHALL BE INSTALLED W/ 1/2" REGLET & THEN SEALED.
- 34.3. FLASH ALL EXTERIOR OPENINGS AND ALL BUILDING CORNERS WITH APPROVED WATERPROOF BUILDING PAPER TO EXTEND AT LEAST 4" BEHIND WALL COVERING.
- 34.4. FLASH AND CAULK- WOOD BEAMS AND OTHER PROJECTIONS THROUGH EXTERIOR WALLS OR ROOF SURFACES.
- 34.5. EXTERIOR SHEATHING 7/16" O.S.B. SHEATHING INSTALLED PER MANUFACTURER'S SPECIFICATIONS UNLESS NOTED OTHERWISE ON DRAWINGS.

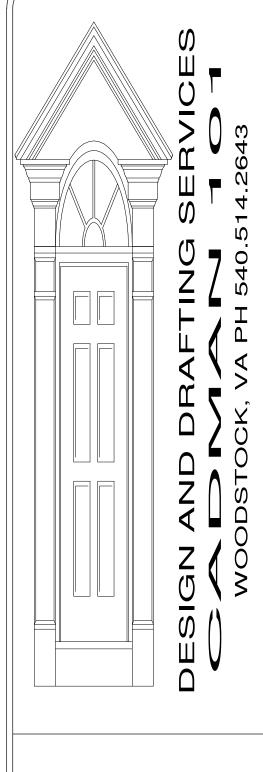
- 34.6. CAULKING / SEALANT AS SELECTED BY BUILDER (OWNER) SUBMIT PRODUCT LITERATURE TO ARCHITECT FOR APPROVAL.
- 34.7. FLASHING WHEN VENEER OF BRICK, CLAY, TILE, CONCRETE OR NATURAL OR ARTIFICIAL STONE ARE USED, 30 MIL PLASTIC FLASHING SHALL BE ATTACHED TO THE SHEATHING WHEREVER NECESSARY TO PREVENT MOISTURE PENETRATION BEHIND THE VENEER & EXTEND TO OR BEYOND THE FACE OF MASONY VENEER.
- 34.8. 30 MIL THROUGH THE WALL FLASHING TO BE PROVIDED AT ALL FLOOR LEVELS IN SUCH A MANOR TO BE LEAK PROOF
- 34.9. ROUGH CARPENTRY CONTRACTORS SHALL SEAL WITH CONSTRUCTION ADHESIVE, PLATES AT FLOOR AND CEILING AND CAULK ALL WINDOWS AND DOOR FLANGES / JAMBS AND ALL PANEL BUTT JOINTS PRIOR TO AND DURING ERECTION.
- 35. FIRESTOPPING SHALL BE PROVIDED TO CUT OFF ALL CONCEALED DRAFT OPENINGS (BOTH VERTICAL AND HORIZONTAL) IN THE FOLLOWING LOCATIONS:
- 35.1. ALL PIPES, DUCTS, VENTS, WIRING AND CHASES WHICH PENETRATE CEILINGS DIRECTLY BELOW A TRUSS OR ROOF ASSEMBLY SHALL BE FIRESTOPPED.
- 35.1.1. IN EXTERIOR OR INTERIOR STUD WALLS, AT CEILING AND FLOOR LEVELS AND SO PLACED THAT THE MAXIMUM DIMENSION OF ANY CONCEALED SPACE IS NOT MORE THAN 10'-0"
- 35.1.2. BETWEEN STAIR STRINGERS AT TOP AND BOTTOM AND BETWEEN STUDS IN LINE WITH STAIR RUN.
- 35.1.3. SPACES BETWEEN CHIMNEYS AND WOOD FRAMING SHALL BE FILLED WITH LOOSE NONCOMBUSTIBLE MATERIAL (2" MIN. THICKNESS). PLACED IN NONCOMBUSTIBLE SUPPORTS TIGHTLY FITTED TO THE CHIMNEY.
- 35.1.4. OTHER LOCATIONS NOT MENTIONED ABOVE SUCH AS HOLES FOR PIPES, SLEEVES, BEHIND FRAMING STRIPS AND OTHER SIMILAR PLACES WHICH COULD AFFORD A PASSAGE FOR FLAMES.
- 35.2. FIRESTOPS WHEN MADE OF WOOD, SHALL BE MINIMUM 2" NOMINAL THICKNESS AND MAY ALSO BE OF 1/2" GYPSUM BOARD, MINERAL WOOL OR OTHER NONCOMBUSTIBLE MATERIAL.
- 35.3. DRAFTSOPPING PROVIDE DRAFTSTOPPING WHERE REQUIRED IN ACCORDANCE WITH APPLICABLE CODES.
- 36. SIDING TO BE AS CALLED FOR ON DRAWINGS AND INSTALLED PER MANUFACTURER'S SPECIFICATIONS.
- 37. VENTILATION PROVIDE ADEQUATE CROSS VENTILATION (MINIMUM AS REQUIRED BY CODE) FOR ALL CONCEALED ATTIC AND RAFTER SPACES. PROVIDE CROSS VENTILATION AS REQUIRED BY CODE FOR CRAWL SPACES.
- 38. IF APPLICABLE, PREFINISHED GUTTERS AND LEADERS LED TO SPLASH BLOCKS.
- 39. ALL WOOD SHALL BE MINIMUM 8" ABOVE FINISH GRADE OR PRESSURE TREATED LESS THAN 8" ABOVE FINISH GRADE. ALL SIDING SHALL BE MINIMUM 6" ABOVE FINISH GRADE.

- 40. DOORS
- 40.1. EXTERIOR ENTRANCE DOORS: 1-3/4" SOLID WOOD CORE HOLLOW METAL MINIMUM 20 GAUGE FILLED WITH SOLID SLAB POLYSTYRENE INSULATION PERMANENTLY BONDED TO PANELS. PROVIDE 1-1/2 PAIR HINGES FOR DOORS UP TO 7'-2" IN HEIGHT AND 2 PAIR HINGES FOR DOORS TO 8'-0" IN HEIGHT. FRAMES TO BE MINIMUM 16 GAUGE GALVANIZED STEEL. SEE DRAWINGS OR RAISED PANEL DESIGN. PROVIDE COMPLETE WEATHER STRIPPING AND METAL THRESHOLD.
- 40.2. GARAGE TO UNIT DOORS: (IF APPLICABLE) TO BE SOLID OR HONEYCOMB CORE STEEL DOOR NOT LESS THAN 1 3/8" (35MM) THICK, OR SOLID WOOD CORE 1-3/8" THICK OR 20-MIN FIRE-RATED DOOR.
 41. WINDOWS
- 41.1. WINDOWS PER MECHANICAL ENERGY CODE

REQUIREMENTS (LOW-E IF REQ'D)

- 41.1.1. WINDOWS TO BE LOW E WITH U FACTOR OF .3 SHGC :0.40 CORDINATE WITH RESCHECK CALULATION.
- 41.2. GENERAL GLAZING IN LOCATIONS SUBJECT TO HUMAN IMPACT SUCH AS ENTRY DOORS AND SKYLIGHTS, SLIDING GLASS DOOR, SHOWER DOORS, TUB ENCLOSURES AND STORM DOORS SHALL BE FULLY TEMPERED IN ACCORDANCE WITH THE IRC CODE, AND MEETS THE FOLLOWING:
- 41.3. FIXED PANELS WITH AREA IN EXCESS OF 9 SQUARE FEET WITH THE LOWEST EDGE LESS THAN 24" ABOVE THE FLOOR OR WALKING SURFACE; TOP EDGE GREATER THAN 36" ABOVE THE FLOOR; ONE OR MORE WALKING SURFACES WITHIN 36" HORIZONTALLY OF THE GLAZED PANEL. SEE IRC CODE FOR EXCEPTIONS TO HAZARDOUS LOCATIONS, IF APPLICABLE. PERMITTED MATERIALS. THE FOLLOWING TYPES OF GLAZING MAY BE USED;
- 41.3.1. LAMINATED GLASS
- 41.3.2. FULLY TEMPERED GLASS
- 41.3.3. HEAT-STRENGTHENED GLASS
- 41.3.4. WIRED GLASS
- 41.3.5. APPROVED RIGID PLASTICS
- 41.4. WEATHER PROOFING ALL SLIDING, SWINGING DOORS AND WINDOWS OPENING TO THE EXTERIOR SHALL BE FULLY WEATHERSTRIPPED, CAULKED, GASKETED OR OTHERWISE TREATED TO LIMIT AIR INFILTRATION. PROVIDE MAXIMUM AIR INFILTRATION AS FOLLOWS:
- 41.4.1. WINDOWS SHALL HAVE AN AIR INFILTRATION RATE OF LESS THAN 0.5 CFM PER FOOT OF SUCH CRACK.
 41.4.2. SLIDING GLASS DOORS SHALL HAVE AN AIR INFILTRATION RATE OF LESS THAN 0.5 CFM PER SQUARE FOOT OF DOOR AREA OR;
- 41.4.3. SWINGING DOORS SHALL HAVE AN AIR INFILTRATION RATE OF LESS THAN 0.5 CFM PER SQUARE FOOT OF DOOR AREA.
- 41.4.4. PROVIDE FLASHING AS PER SMACNA AT ALL WINDOW HEADS.

- 41.5. EMERGENCY EGRESS IN ACCORDANCE W/ IRC CODE, BASEMENTS WITH HABITABLE SPACE AND EVERY SLEEPING ROOM BELOW THE FOURTH STORY SHALL HAVE AT LEAST ONE OPERABLE WINDOW OR DOOR FOR EMERGENCY EGRESS OR RESCUE. EGRESS WINDOWS SHALL HAVE A MAXIMUM SILL HEIGHT OF 44" ABOVE FINISHED FLOOR AND SHALL HAVE A MINIMUM NET CLEAR OPENING OF 5.7 SQUARE FEET WITH A MINIMUM CLEAR OPENING HEIGHT OF 24" AND MINIMUM OPENING WIDTH OF 20". GRADE FLOOR WINDOWS MAY HAVE A MINIMUM NET CLEAR OPENING OF 5 SQUARE FEET.
- 41.6. EMERGENCY ESCAPE AND RESCUE OPENINGS SHALL BE OPERATIONAL FROM THE INSIDE OF THE ROOM WITHOUT THE USE OF KEYS OR TOOLS. WINDOW WELLS SHALL HAVE HORIZONTAL DIMENSIONS THAT ALLOW THE EGRESS DOOR OR WINDOW TO BE FULLY OPENED.
- 41.7. ALL OPERABLE WINDOWS SHALL HAVE NONCORROSIVE SCREENS AND SASH LOCKS.
- 42. FINISHES
- 42.1. GYPSUM WALLBOARD SHALL BE INSTALLED IN ACCORDANCE WITH U.S. GYPSUM RECOMMENDATIONS AND SHALL MEET THE REQUIREMENTS OF CURRENT OR APPLICABLE APPLICABLE CODES. TYPICAL INTERIOR PARTITIONS TO HAVE 1/2" TAPERED EDGE, TAPED AND FINISHED. PROVIDE 5/8" TYPE "X" FIRE RATED GYPSUM BOARD AT WALLS AND CEILINGS WHERE CALLED FOR ON THE DRAWINGS.
- 42.2. GYPSUM WALLBOARD SHALL NOT BE INSTALLED UNTIL WEATHER PROTECTION FOR THE INSTALLATION IS PROVIDE.
- 42.3. SUPPORT ALL EDGES AND ENDS OF GYPSUM BOARD SHALL OCCUR ON FRAMING MEMBERS EXCEPT THOSE EDGES PERPENDICULAR TO FRAMING MEMBERS.
- 42.4. MOISTURE RESISTANT GYPSUM BOARD PROVIDE MOISTURE RESISTANT GYPSUM BOARD AT ALL BATHROOMS AND WHEREVER MOISTURE CONDITIONS CAN EXIST.
- 42.5. J BEAD- SHOULD BE USED WITH MOISTURE RESISTANT GYPSUM BOARD AND WEREVER MOISTURE CONDITIONS CAN EXIST.
- 42.6. CERAMIC TILE CERAMIC TILE SHALL BE 4 1/4" X 4 1/4" GLAZED TILE, THIN SET APPLICATION ON MOISTURE RESISTANT DRYWALL. PROVIDE BASE AND MISCELLANEOUS TRIM. THE COLOR AS SELECTED BY OWNER. PROVIDE MARBLE THRESHOLD FOR TRANSITION BETWEEN CERAMIC FLOOR TILE AND OTHER FLOOR FINISHES. FLOOR TILE SHALL BE NON-SLIP. GROUT COMMERCIAL WATERPROOF GROUT CEMENT.
- 42.7. RESILIENT FLOORING- SHALL BE SHEET VINYL OR VINYL COMPOSITION TILE INSTALLED AS PER MANUFACTURER'S SPECIFICATIONS. FLOOR AND SHALL HAVE A MINIMUM NET CLEAR OPENING OF 5.7 SQUARE FEET WITH A MINIMUM CLEAR OPENING HEIGHT OF 24" AND MINIMUM OPENING WIDTH OF 20". GRADE FLOOR WINDOWS MAY HAVE A MINIMUM NET CLEAR OPENING OF 5 SQUARE FEET.



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MINERAL VA 23117
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- 43. SPECIALTIES

 A. BATH VANITIES AS SELECTED BY BUILDER (OWNER)

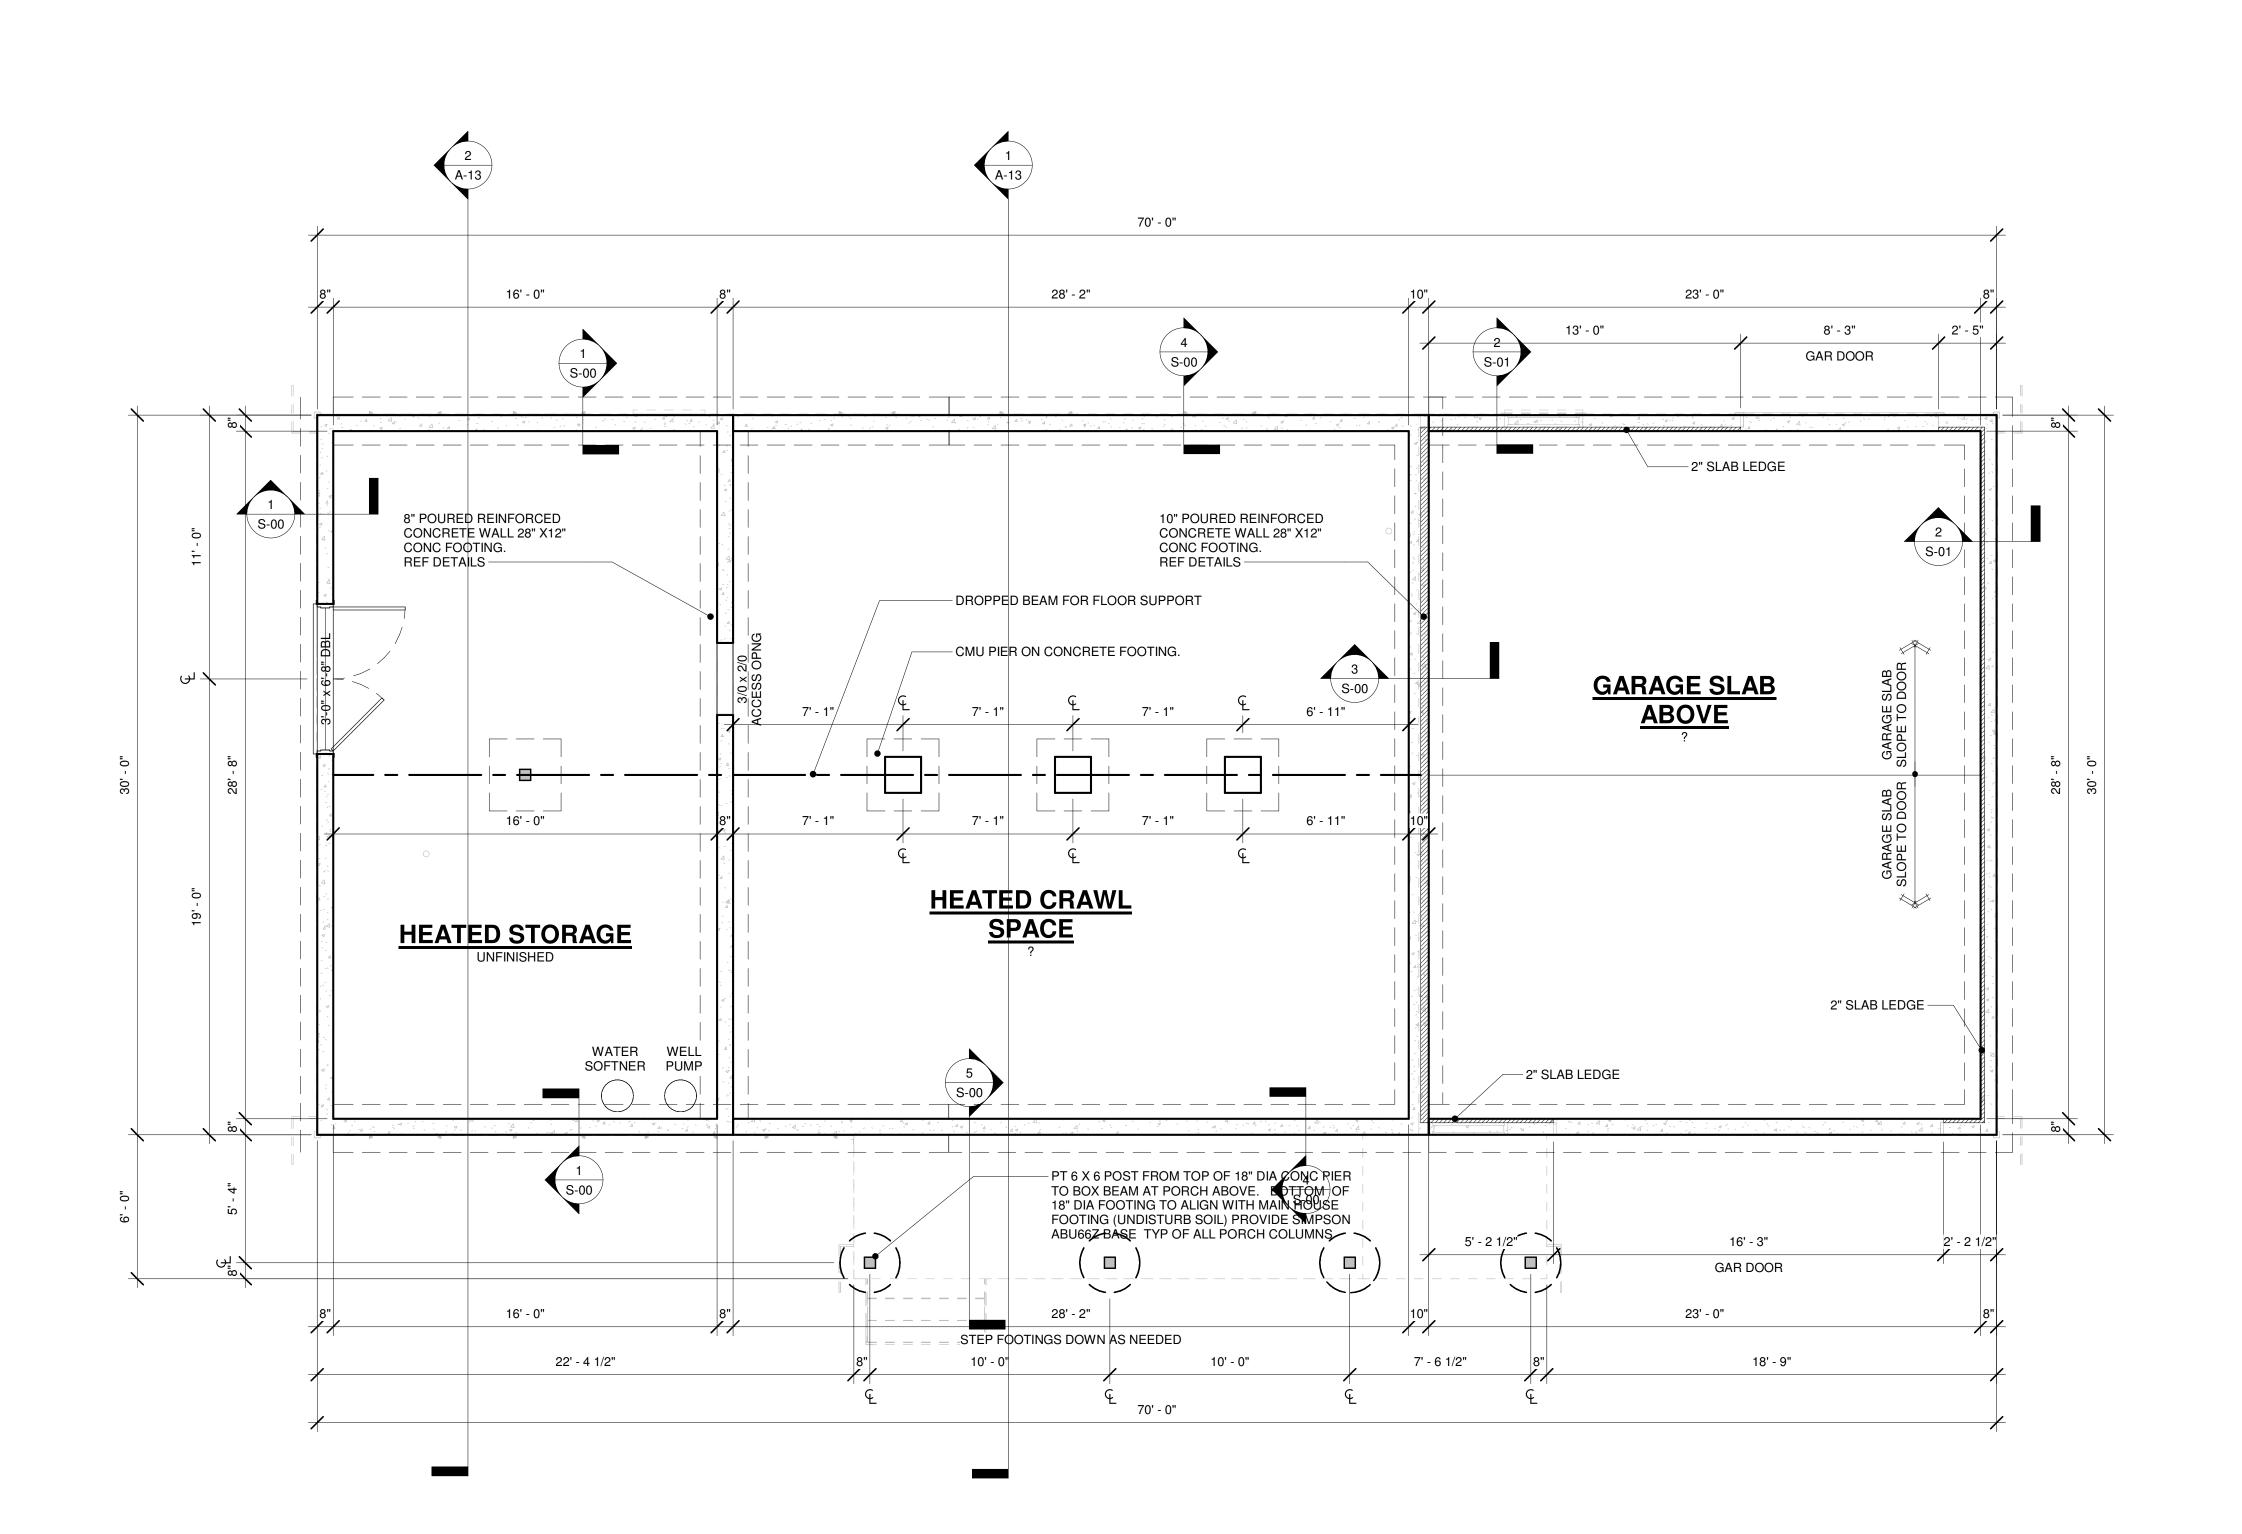
 B. BATH FIXTURES- AS SELECTED BY BUILDER (OWNER)

 44. EQUIPMENT NONE
- 45. FURNISHINGS NONE
- 46. SPECIAL CONSTRUCTION NONE
- 47. CONVEYING SYSTEMS NONE
- 48. MECHANICAL
- 48.1. H.V.A.C. KITCHEN AND BATH VENTILATION METAL DUCTS TO EXTERIOR WHERE INDICATED AND/OR REQUIRED BY APPLICABLE CODES. COMPLETE INSTALLATION CIRCULATING AIR COMBUSTION TO MEET ALL REQUIREMENTS OF THE MANUFACTURER AND THE STATE.
- 49. PLUMBING
- 49.1. SANITARY: COLD AND HOT WATER: AND ALL OTHER PIPING SHALL CONFORM TO THE REQUIREMENTS, LOCAL AND THE STATE.
- 49.2. PROVIDE MINIMUM 21" WALKING SPACE IN FRONT OF ALL PLUMBING FIXTURES IN BATHROOM AND 14" x 30" ACCESS PANEL AT TUB CONNECTIONS UNLESS OTHERWISE NOTED. ALL SHOWER STALLS SHALL HAVE A MINIMUM FINISHED AREA OF 1024 SQUARE INCHES WITH A MINIMUM OF 30" IN ANY DIRECTION. WATER CLOSETS TO BE A MINIMUM OF 15" FROM WALL TO CENTERLINE OF FIXTURE.
- 50. ELECTRICAL
- 50.1. ELECTRICAL SHALL CONFORM TO THE REQUIREMENTS OF THE NATIONAL ELECTRICAL CODE, THE LOCAL POWER COMPANY AND ALL APPLICABLE LOCAL REGULATIONS. OBTAIN ALL PERMITS AND PAY FEES REQUIRED BY THIS WORK. HAVE THE INSTALLATION INSPECTED AND APPROVED BY AN INSPECTION AGENCY OF THE FIRE UNDERWRITER'S ASSOCIATION. SUBMIT A CERTIFICATE OF FINAL APPROVAL BY THE INSPECTION AGENCY UPON COMPLETION. FIXTURES AND APPARATUS AS SELECTED BY BUILDER UNLESS OTHERWISE NOTED.
- 50.2. SMOKE DETECTORS ARE REQUIRED AND SHALL BE INSTALLED OUTSIDE OF EACH SEPARATE SLEEPING AREA, IN EACH SLEEPING ROOM, AND ON EACH ADDITIONAL STORY OF THE DWELLING INCLUDING BASEMENTS AND CELLARS (IF APPLICABLE) BUT NOT IN UNINHABITABLE SPACES. ALL DETECTORS SHALL BE INTERCONNECTED, APPROVED AND LISTED AND SHALL BE INSTALLED IN ACCORDANCE WITH THE MANUFACTURER'S INSTRUCTIONS. ALL DETECTORS SHALL BE INSTALLED WITH BATTERY BACK-UP.
- 50.3. RECESSED LIGHTS WITH THE THERMAL ENVVELOPE SHAL BE IC RATED AND LABELED ASTM E283

DESIGN HOME **FAMILY** 72 DOUGLAS RD, MINERAL VA 23117 BUILDING CODE SINGL NO ISSUE / REVISION SHEET NUMBER A-05

RELEASE TO OWNER FOR PERMITS 09/09/2024

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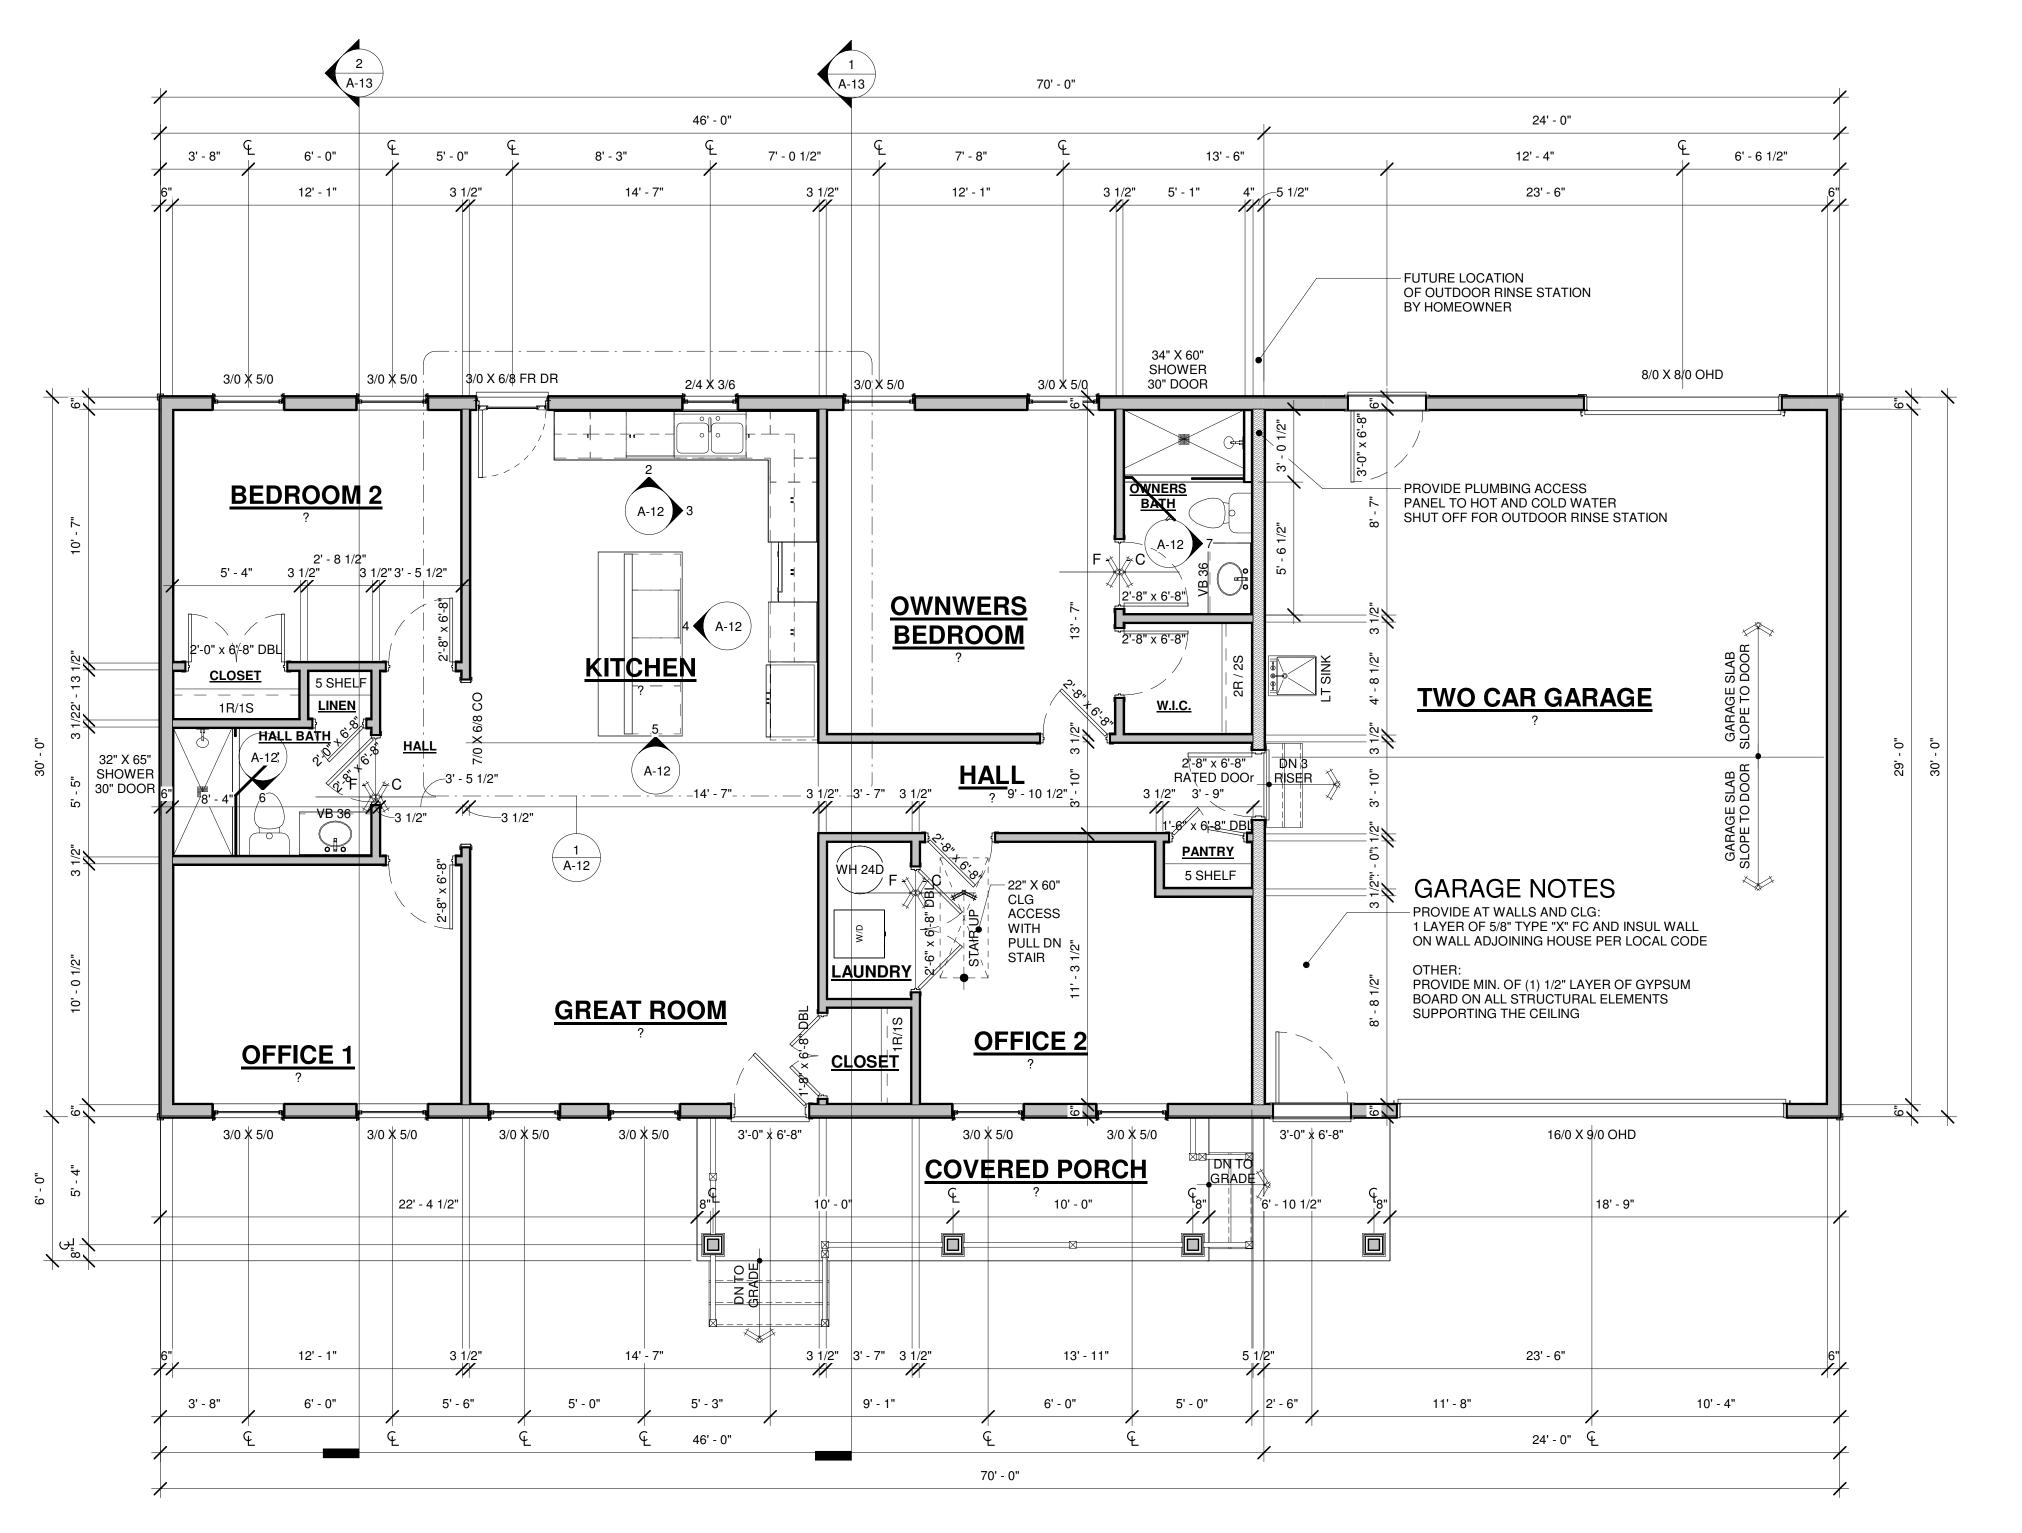


1 A.0 0 LOWER LEVEL PLAN
Scale 1/4" = 1'-0"



D ISSUE	NEW SINGLE FAMILY HOME	
REVISION	72 DOUGLAS RD, MINERAL VA 23117	
DATE	LOWER LEVEL PLAN	DESIGN AND DRAFTING SERVICE
		WOODSTOCK, VA PH 540.514.2643

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FLOOR PLAN GENERAL NOTES

- 1. REFERENCE FRONT ELEVATIONS FOR HEADER HEIGHTS OF FEATURE WINDOWS.
- 2. FIRST FLOOR HEADER HEIGHTS VARY PER ELEVATION & LOCATION
- . KITCHEN WINDOW SILL HEIGHT TO BE SET AT 42" A.F.F.
- 4. FLOOR TRUSS OR FLOOR JOIST SPACING TO BE A MAX. OF 19.2" O.C. UNLESS OTHERWISE NOTED SEE FRAMING PLANS
- 5. ALL SHEATHING USED FOR SUB FLOORING WILL BE GLUED AND SCREWED WITH 1 5/8" SCREW AT FOUR (4) INCHES O.C. AT EDGES AND EIGHT (8) INCHES O.C. IN FIELD. ALL EDGES REQUIRE A 1/16 INCH GAP. ALL TONGUE AND GROOVE JOINTS WILL RECEIVE A BEAD OF GLUE. GLUING AND SCREWING WILL BE ACCOMPLISHED ONE SHEET AT A TIME.
 6. ROOF SHEATHING WILL BE 7/16" EXTERIOR GRADE PLYWOOD OR EQUAL, NAILED FOUR (4)
- INCHES O.C. AT ALL EDGES AND EIGHT (8) INCHES O.C. IN FIELD WITH A 1/8" GAP AT ALL EDGES. LEAVE TWO (2) INCHES OF GAP AT RIDGE VENT AS REQUIRED.

 7. CERAMIC TILE FLOORS SHOULD BE SUPPORTED PER TILE COUNCIL OF AMERICA (TCA)
- 7. CERAMIC TILE FLOORS SHOULD BE SUPPORTED PER TILE COUNCIL OF AMERICA (TO RECOMMENDATIONS.
- . VERIFY LOCATION OF PLUMBING DROPS AND SHIFT JOISTS A MAXIMUM OF 2 INCHES.
- HANGERS TO BE INSTALLED PER MANUFACTURERS' RECOMMENDATIONS.
- 10. ALL ROOF FRAMING WOOD TRUSSES TO BE SET AT A MAX. OF 24" O.C. U.N.O.11. ALL ROOF TRUSSES TO BE ATTACHED PER STRUCTURAL ENGINEER'S NOTES.
- 12. ALL ROOF TRUSSES TO BE INSTALLED PER MANUFACTURER'S INSTRUCTIONS
- 13. ROOF TRUSS MANUFACTURER TO SUPPLY CERTIFIED ENGINEERED SHOP DRAWINGS.
- 14. ALL SMOKE DETECTORS TO BE 110V WITH BATTERY BACKUP AND INTERCONNECTED
- 15. PROVIDE BRACING FOR ALL CEILING FAN OUTLETS.
- 16. CARBON MONOXIDE ALARMS TO BE INSTALLED PER IRC 2018
- 17. ALL STAIRS, HANDRAILS, AND GUARDS SHALL BE CONSTRUCTED IN ACCORDANCE WITH
- 18. ALL INTERIOR PARTITIONS NOT DIMENSIONED SHALL BE 3 1/2" UNLESS NOTED OTHERWISE
- 19. ALL EXTERIOR PARTITIONS ARE 6" UNLESS NOTED OTHERWISE.
- 20. ALL INTERIOR DIMENSIONS ARE TAKEN FROM FACE OF STUD
- 21. ALL EXTERIOR DIMENSIONS ARE TAKEN FROM FACE OF SHEATHING
- 22. ALL ANGLES ARE 90 AND/OR 45 DEGREES UNLESS NOTED OTHERWISE
- 23. ALL WINDOW DIMENSIONS ARE GIVEN IN FEET AND INCHES.
- EXAMPLE: 3/0 5/0 = 3'-0" (W) X 5'-0" (H)
 24. ALL DOOR DIMENSIONS ARE GIVEN IN FEET AND INCHES.
 - EXAMPLE: 30X68 = 3'-0" (W) X 6'-8" (H)
- 25. BATH WALLS WITH TILE TO HAVE 1/2" CEMENT BOARD
- 26. ALL OTHER BATH WALLS TO BE MOISTURE RESISTANT GREEN BOARD

 27. SILL HEIGHT IS BASED ON WINDOW SIZE AND WINDOW HEAD HEIGHT INDICATED ON
- ELEVATIONS. IN LOCATIONS WHERE THE SILL IS LESS THAN 18" AND THE FINISH GRADE OR SURFACE ON THE EXTERIOR SIDE IS MORE THAN 72" OPERABLE WINDOWS MUST HAVE A GUARD INSTALLED IN ACCORDANCE IRC CODE.
- 28. NOTE: THESE PLANS ARE SUBJECT TO MODIFICATION AS NECESSARY TO MEET CODE REQUIREMENTS OR TO FACILITATE MECHANICAL/PLUMBING INSTALLATION OR TO INCORPORATE DESIGN IMPROVEMENTS.

NEW SINGLE FAMILY HOME
72 DOUGLAS RD,
MINERAL VA 23117
FIRST FLOOR PLAN

30/60

OWNER

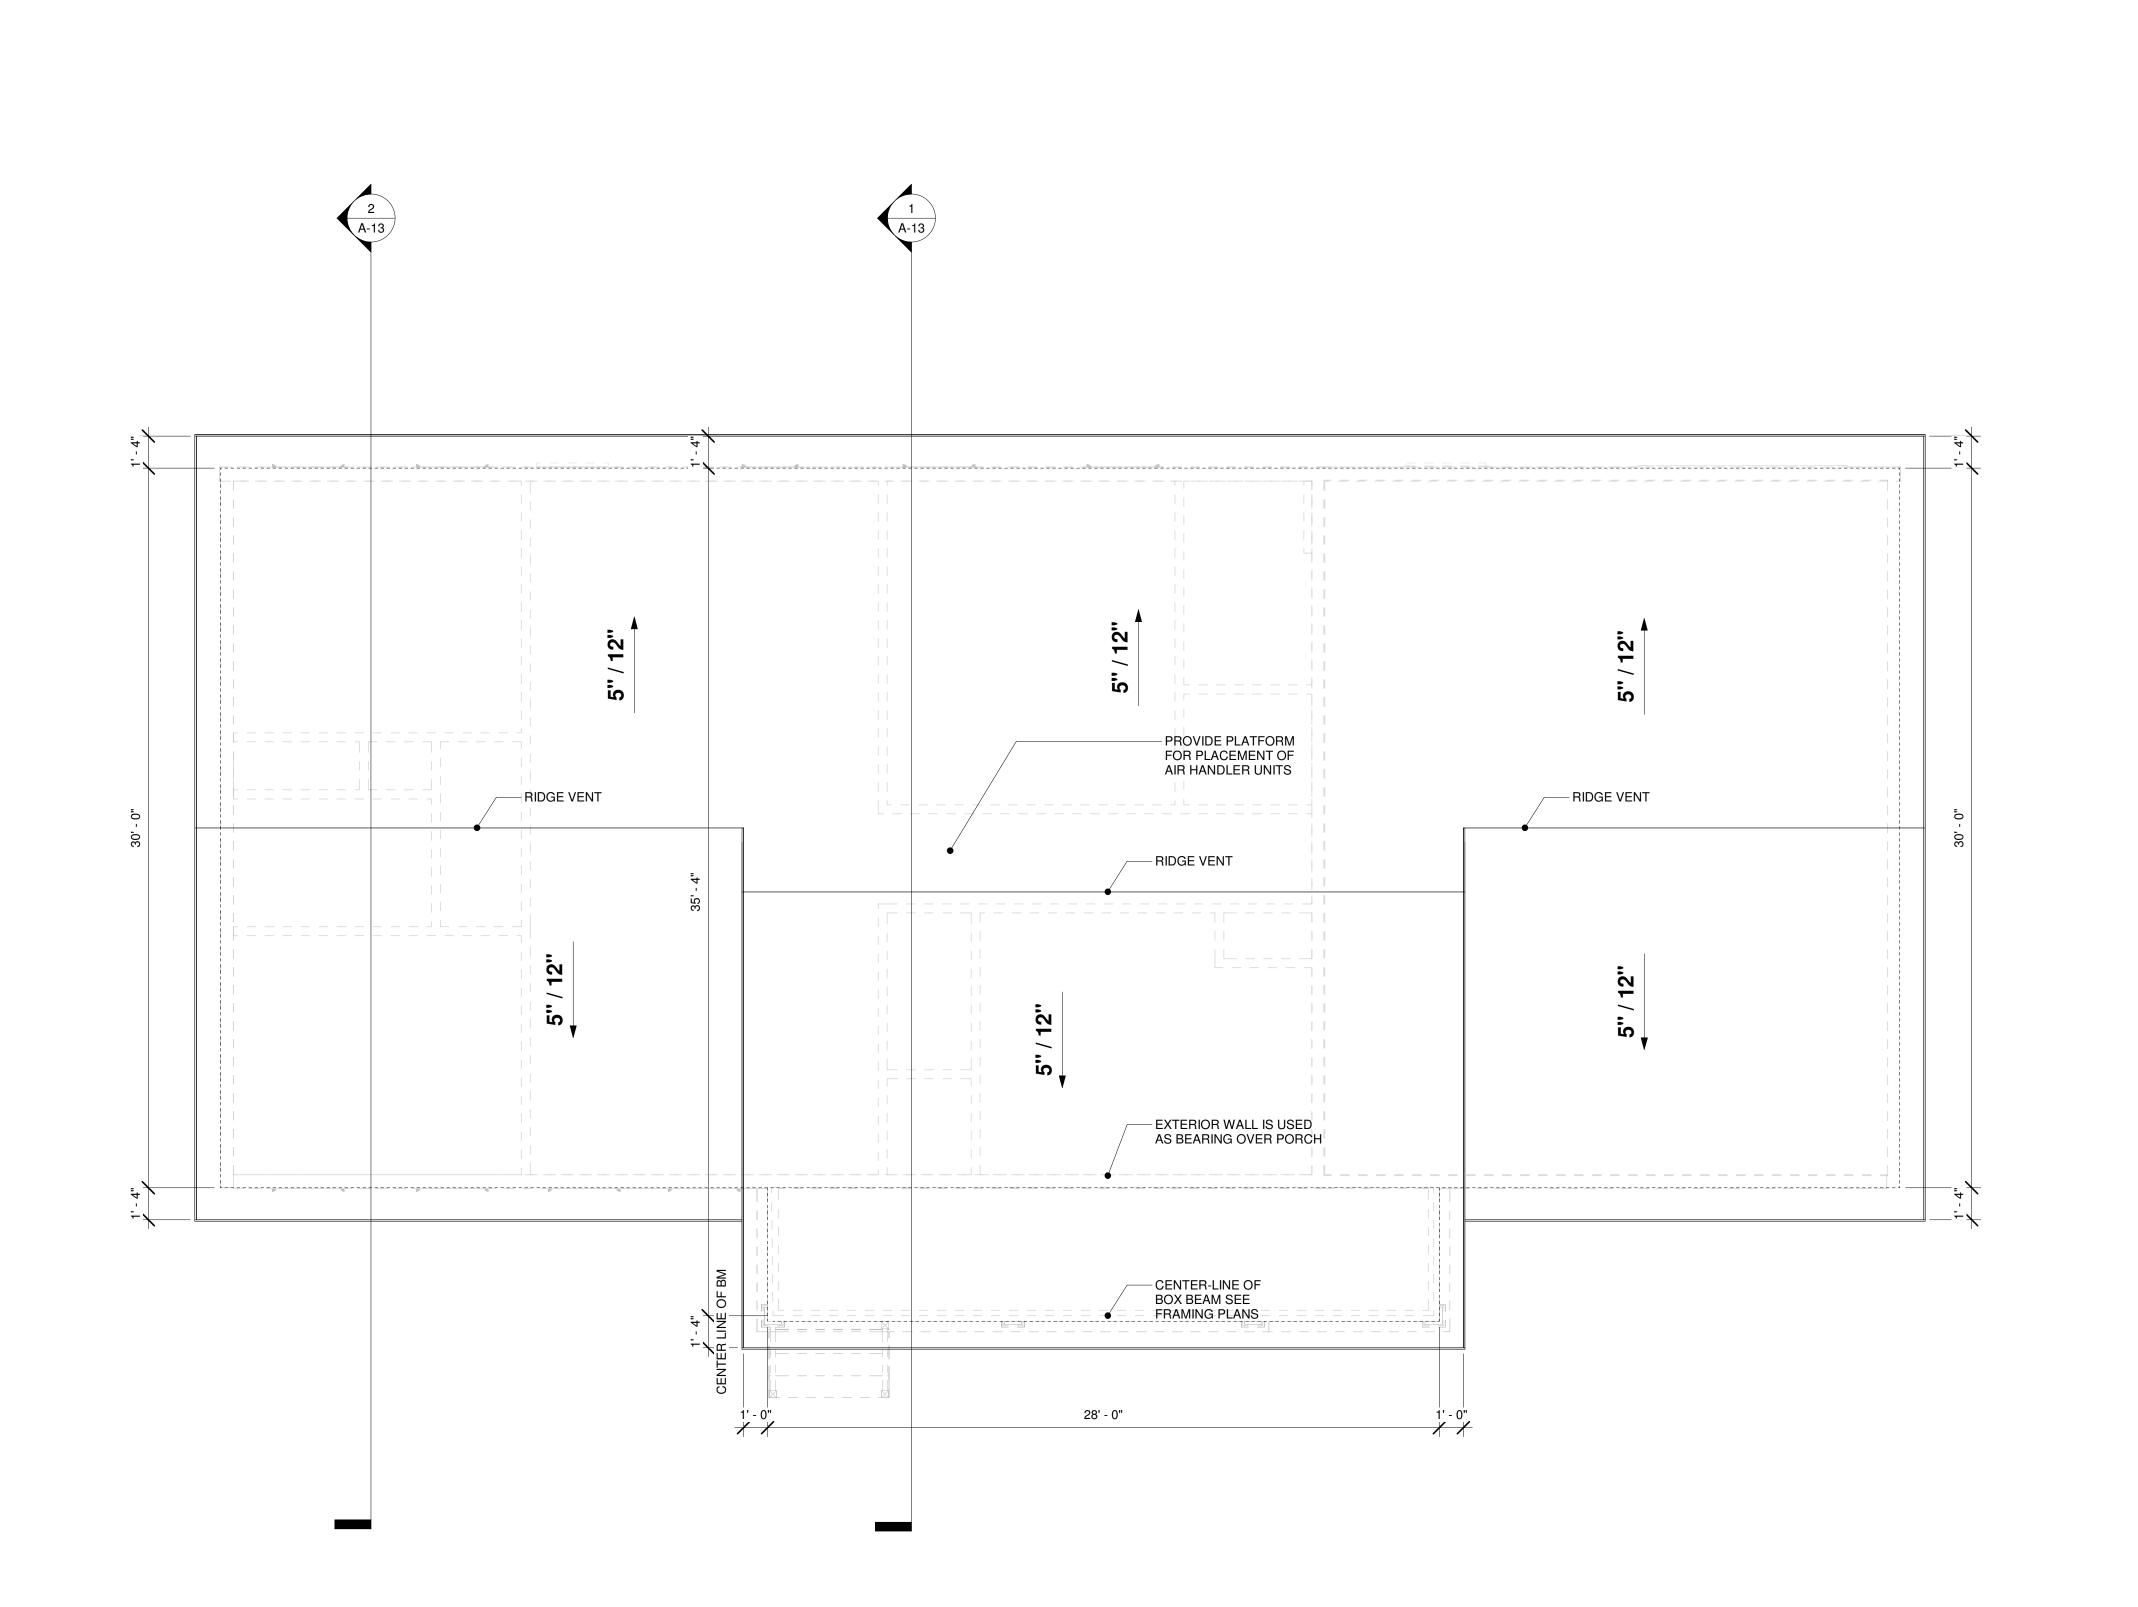
RELEASE

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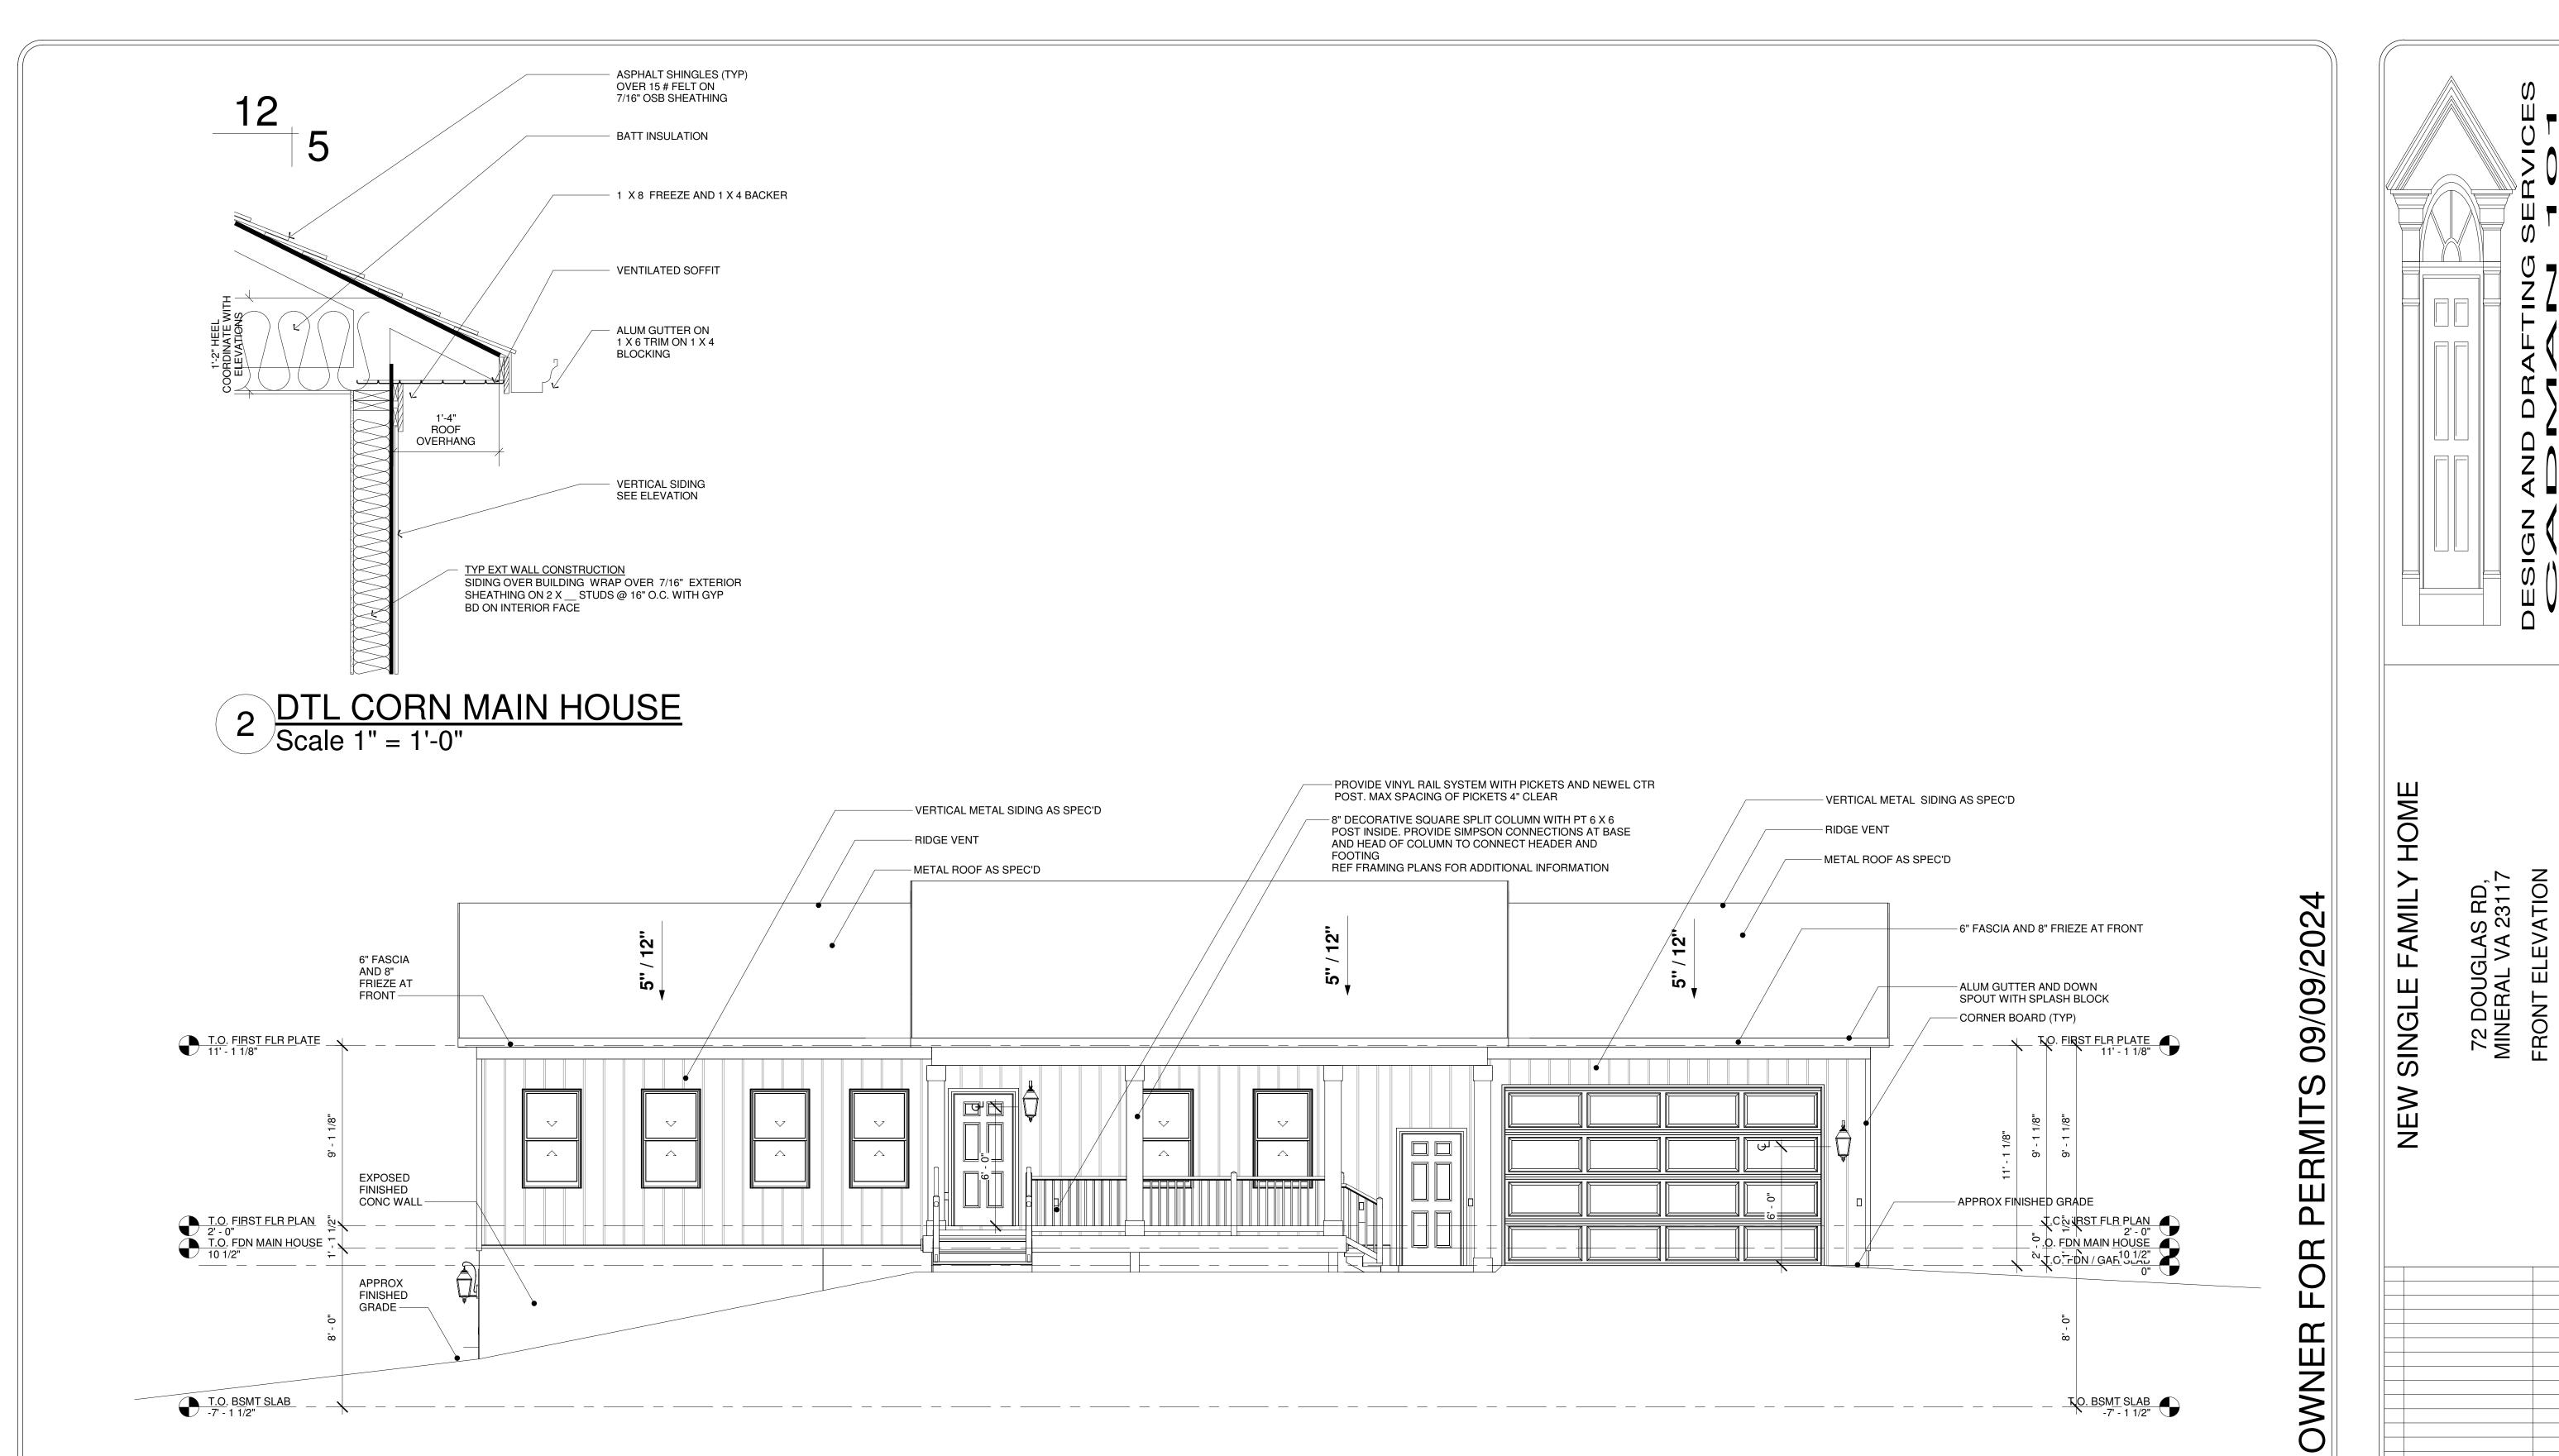
1 A.0 1 FIRST FLOOR PLAN Scale 1/4" = 1'-0"



RELEASE TO OWNER FOR PERMITS 09/09/2024

NEW SINGLE FAMILY HOME 72 DOUGLAS RD, MINERAL VA 23117 ROOF PLAN NO_ISSUE / REVISION DATE PROJECT NUMBER: DRAWN BY: CHECKED BY: DATE: M326a MAC MAC SHEET NUMBER A-08

1 A.0 2 ROOF PLAN Scale 1/4" = 1'-0"



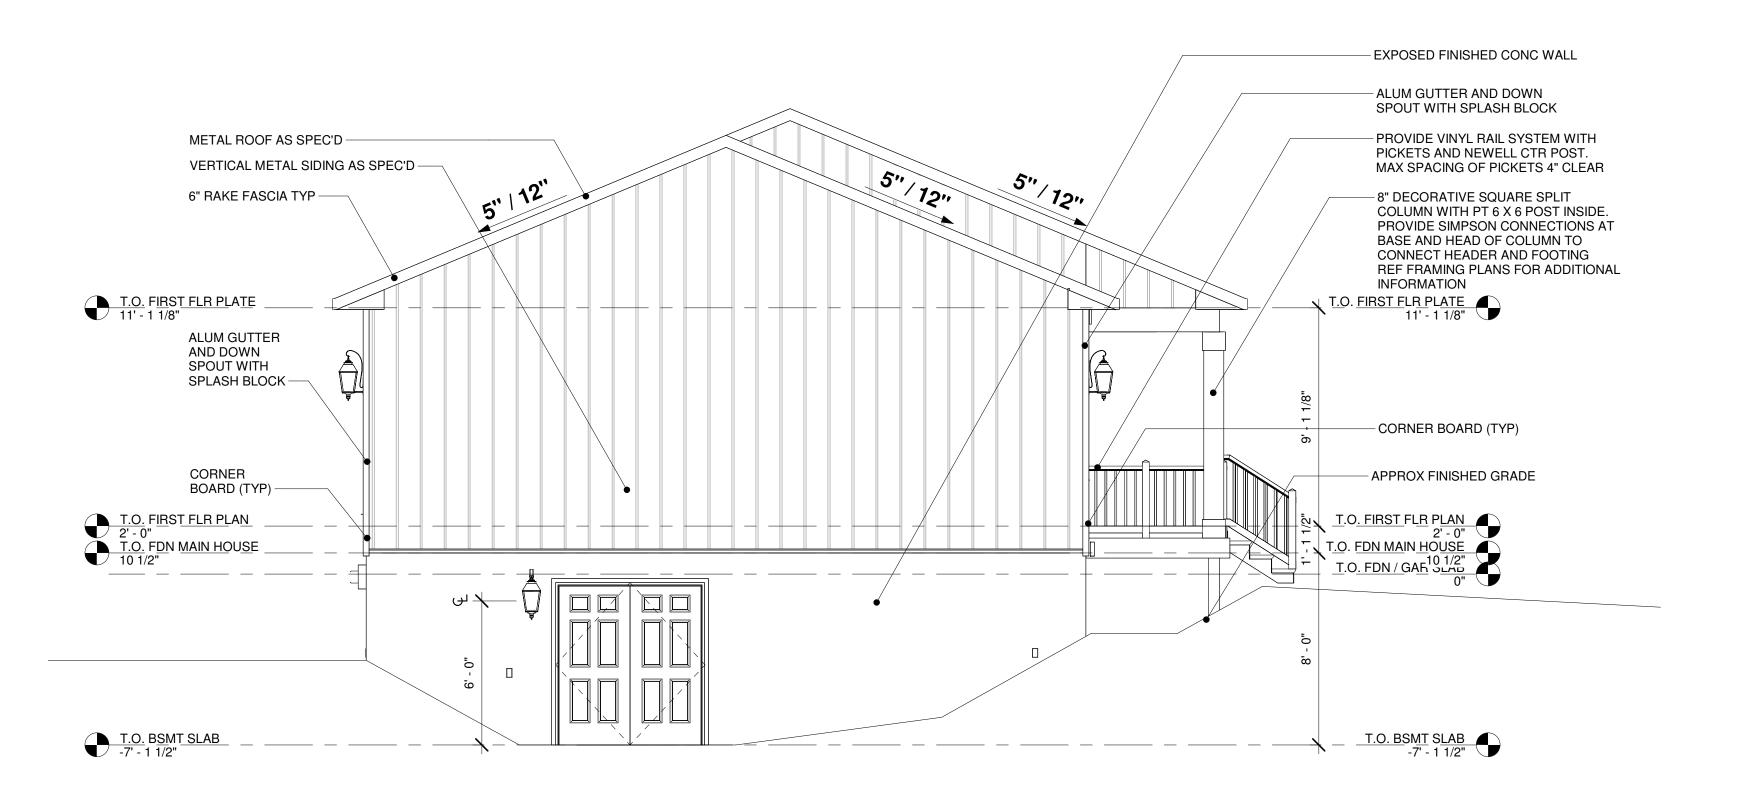
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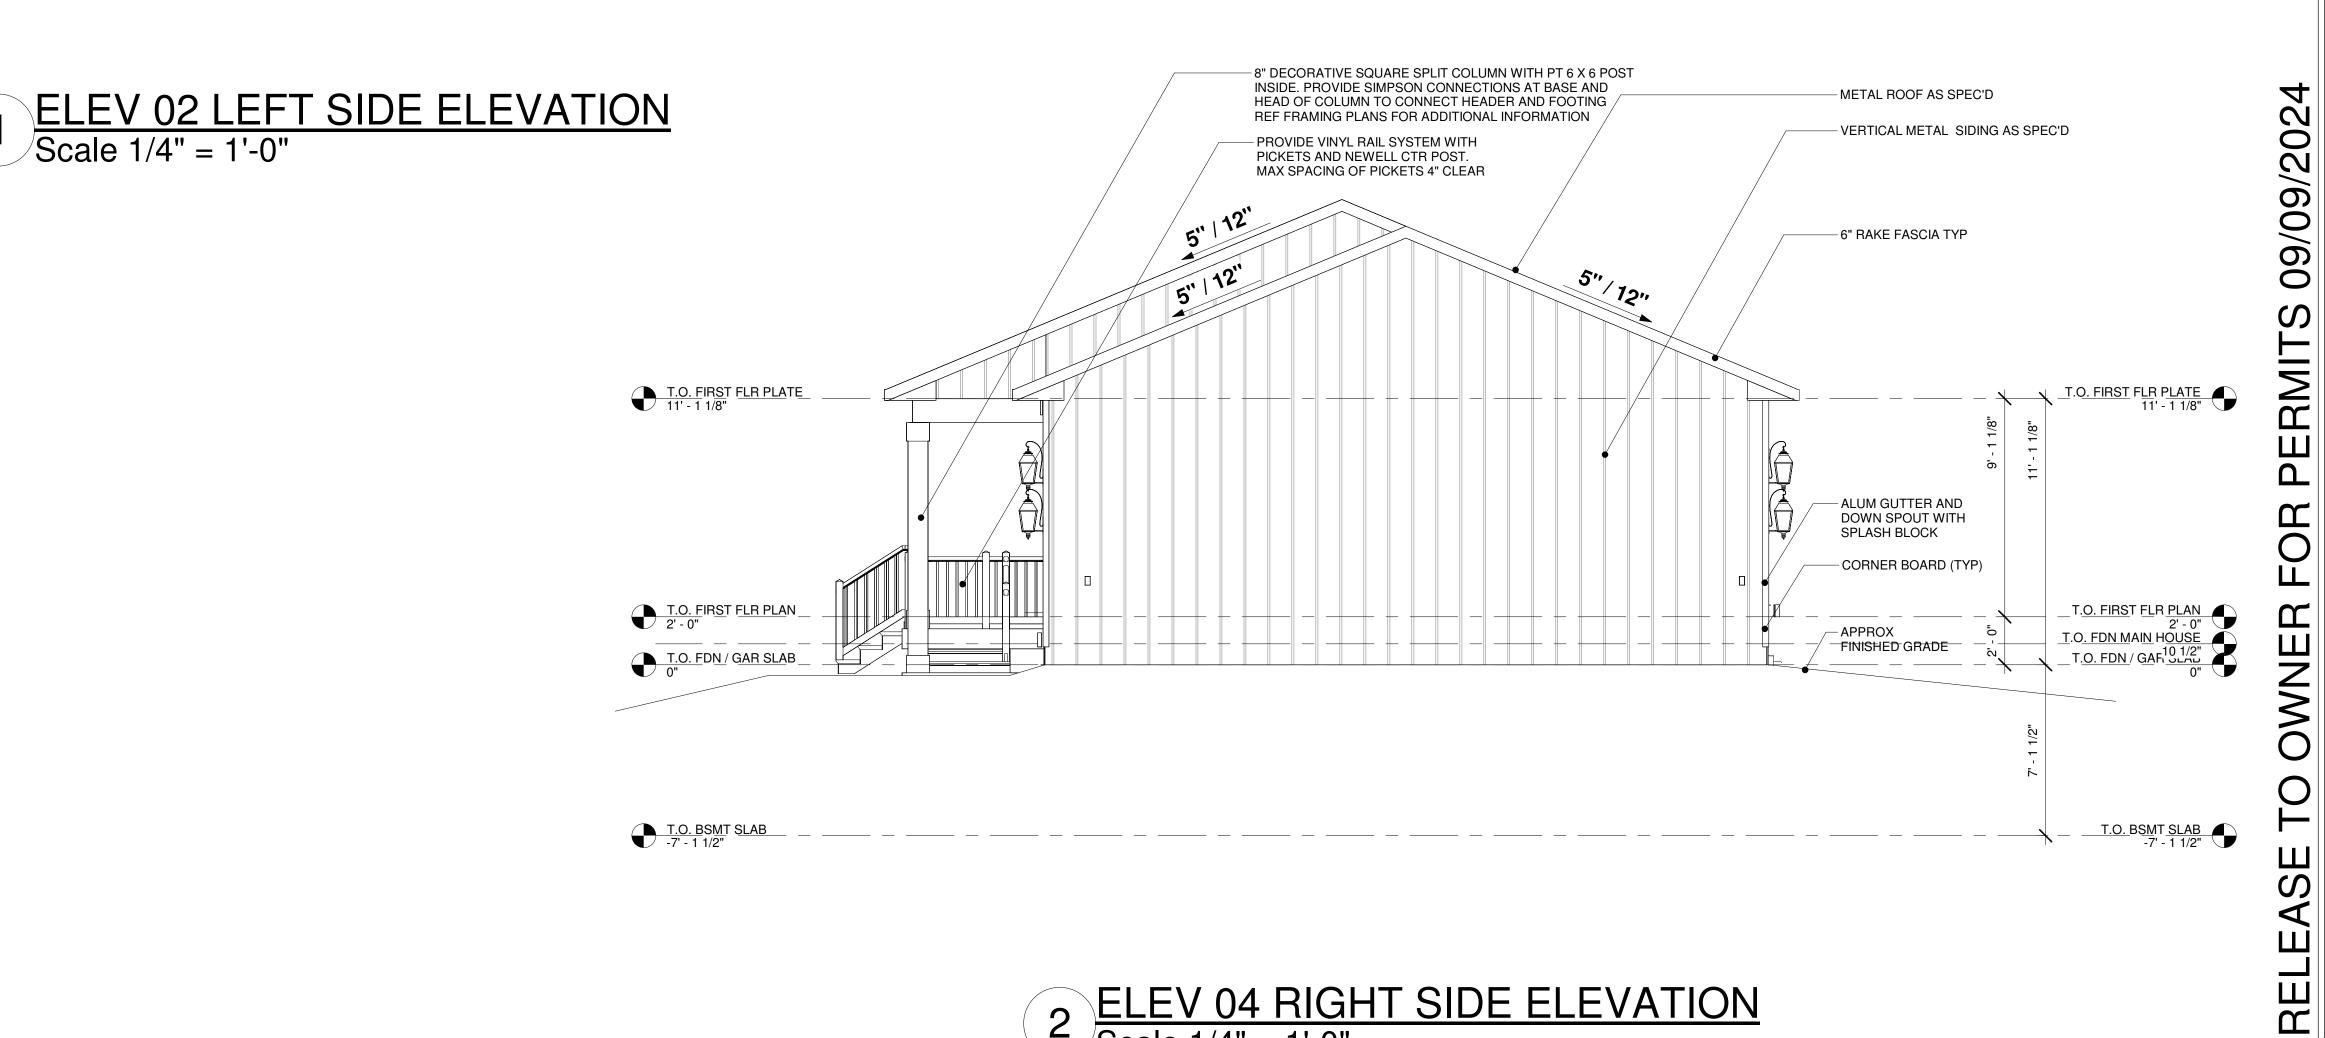
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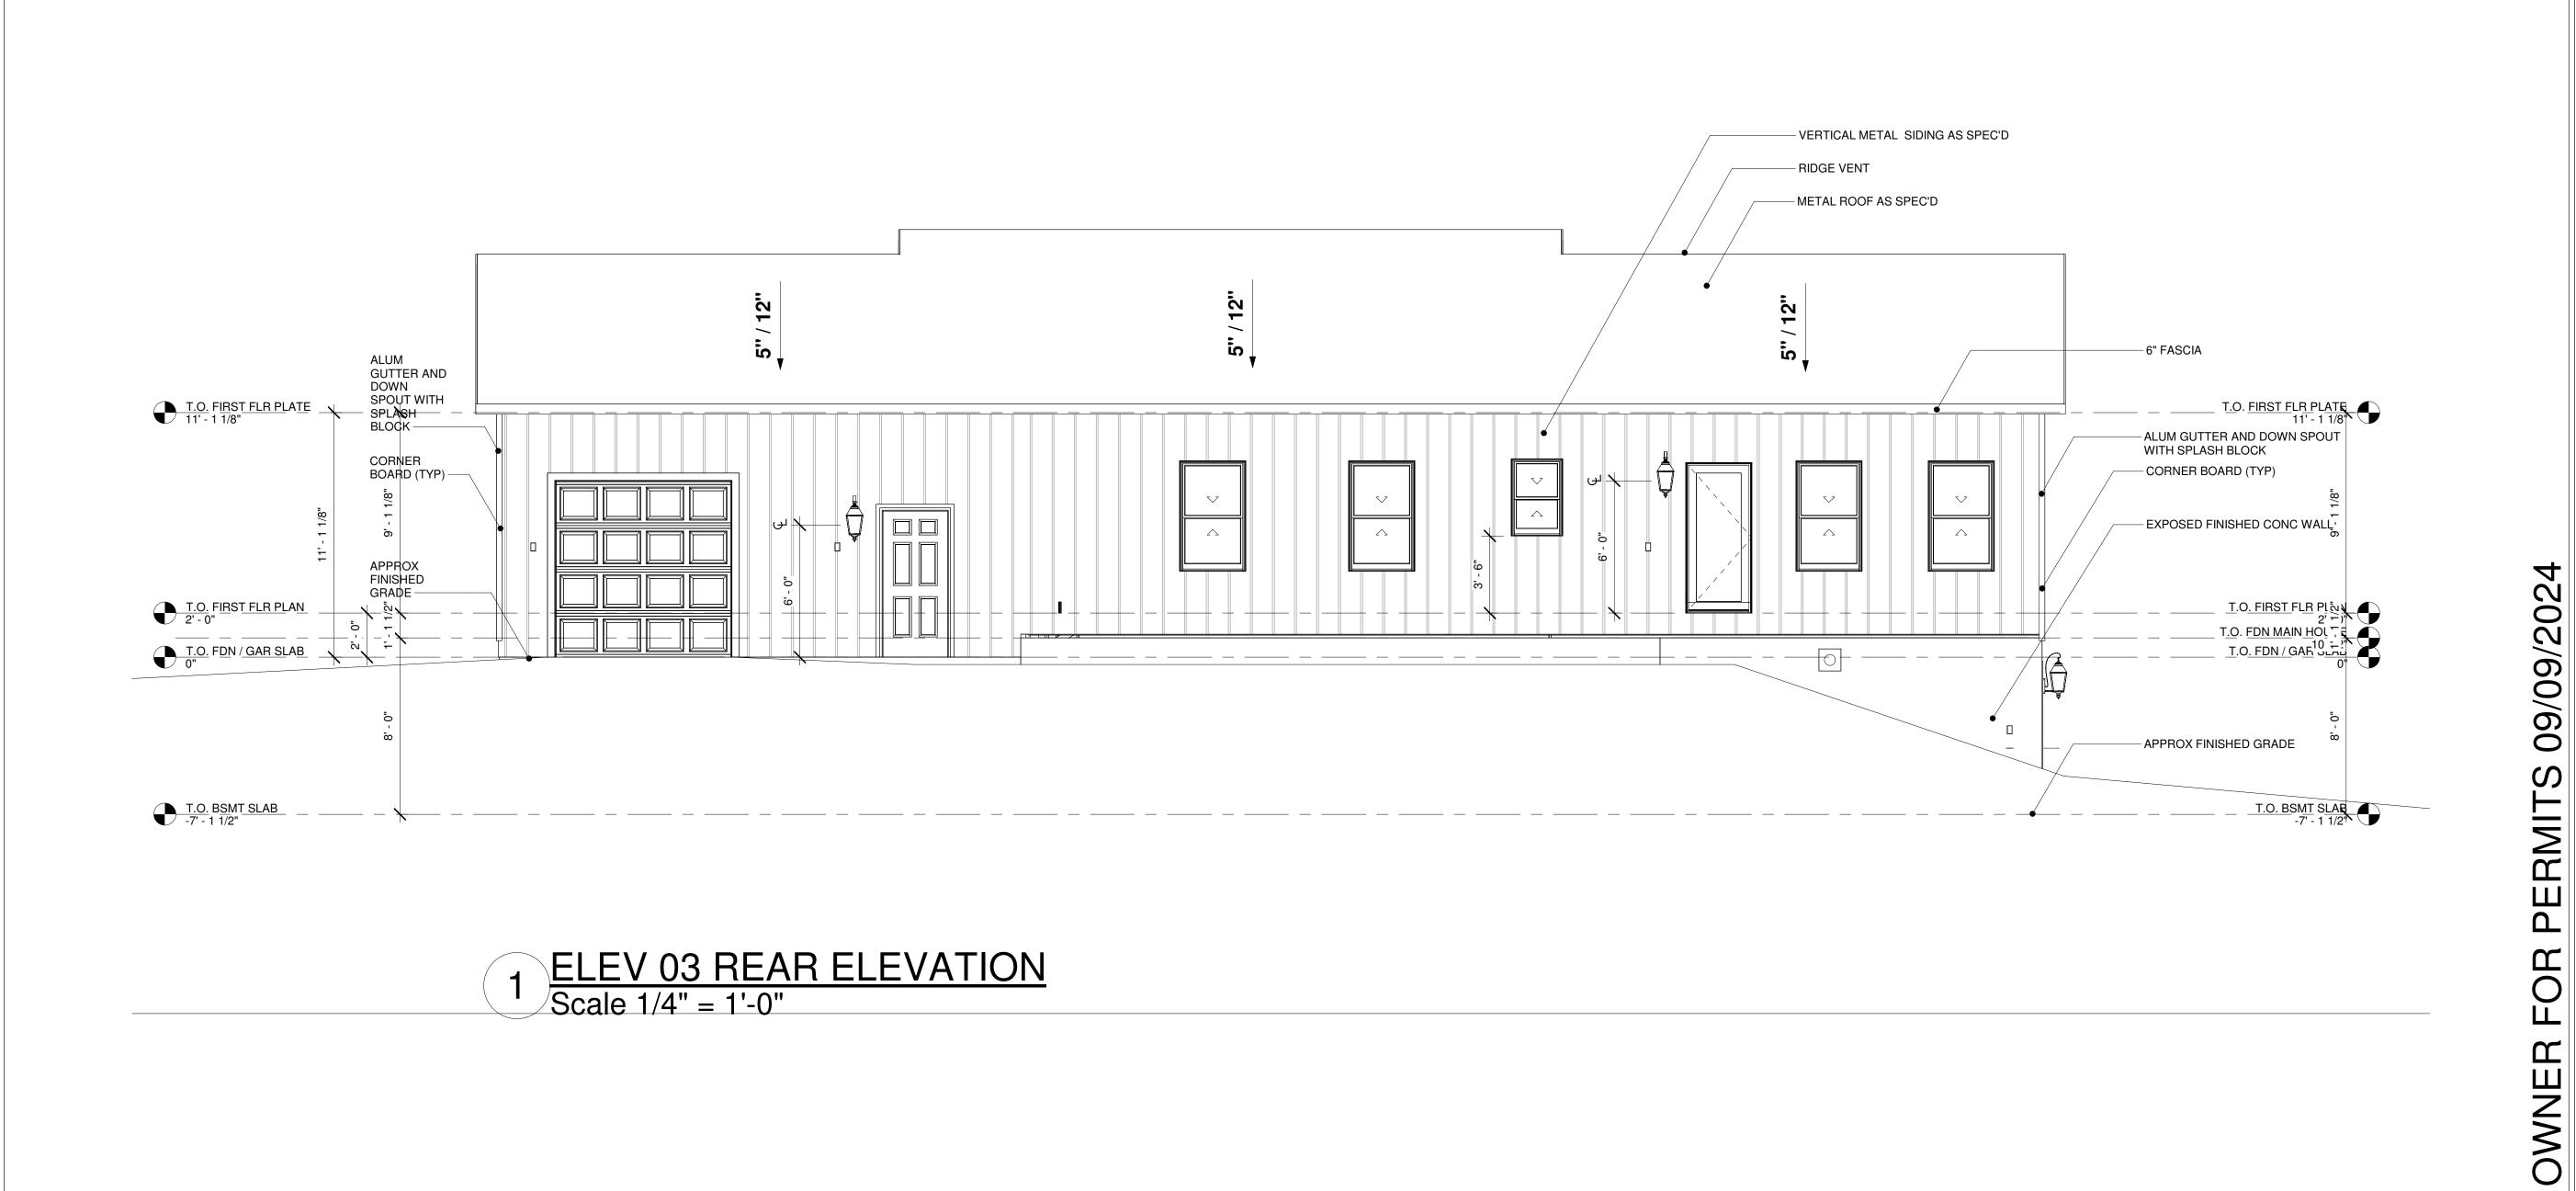


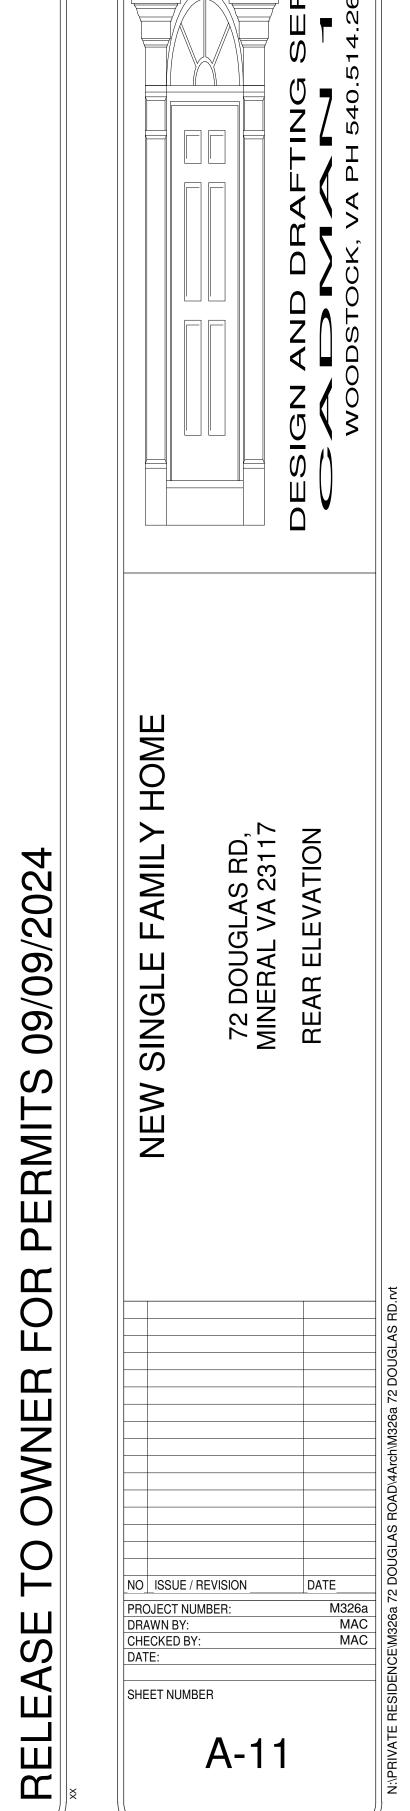




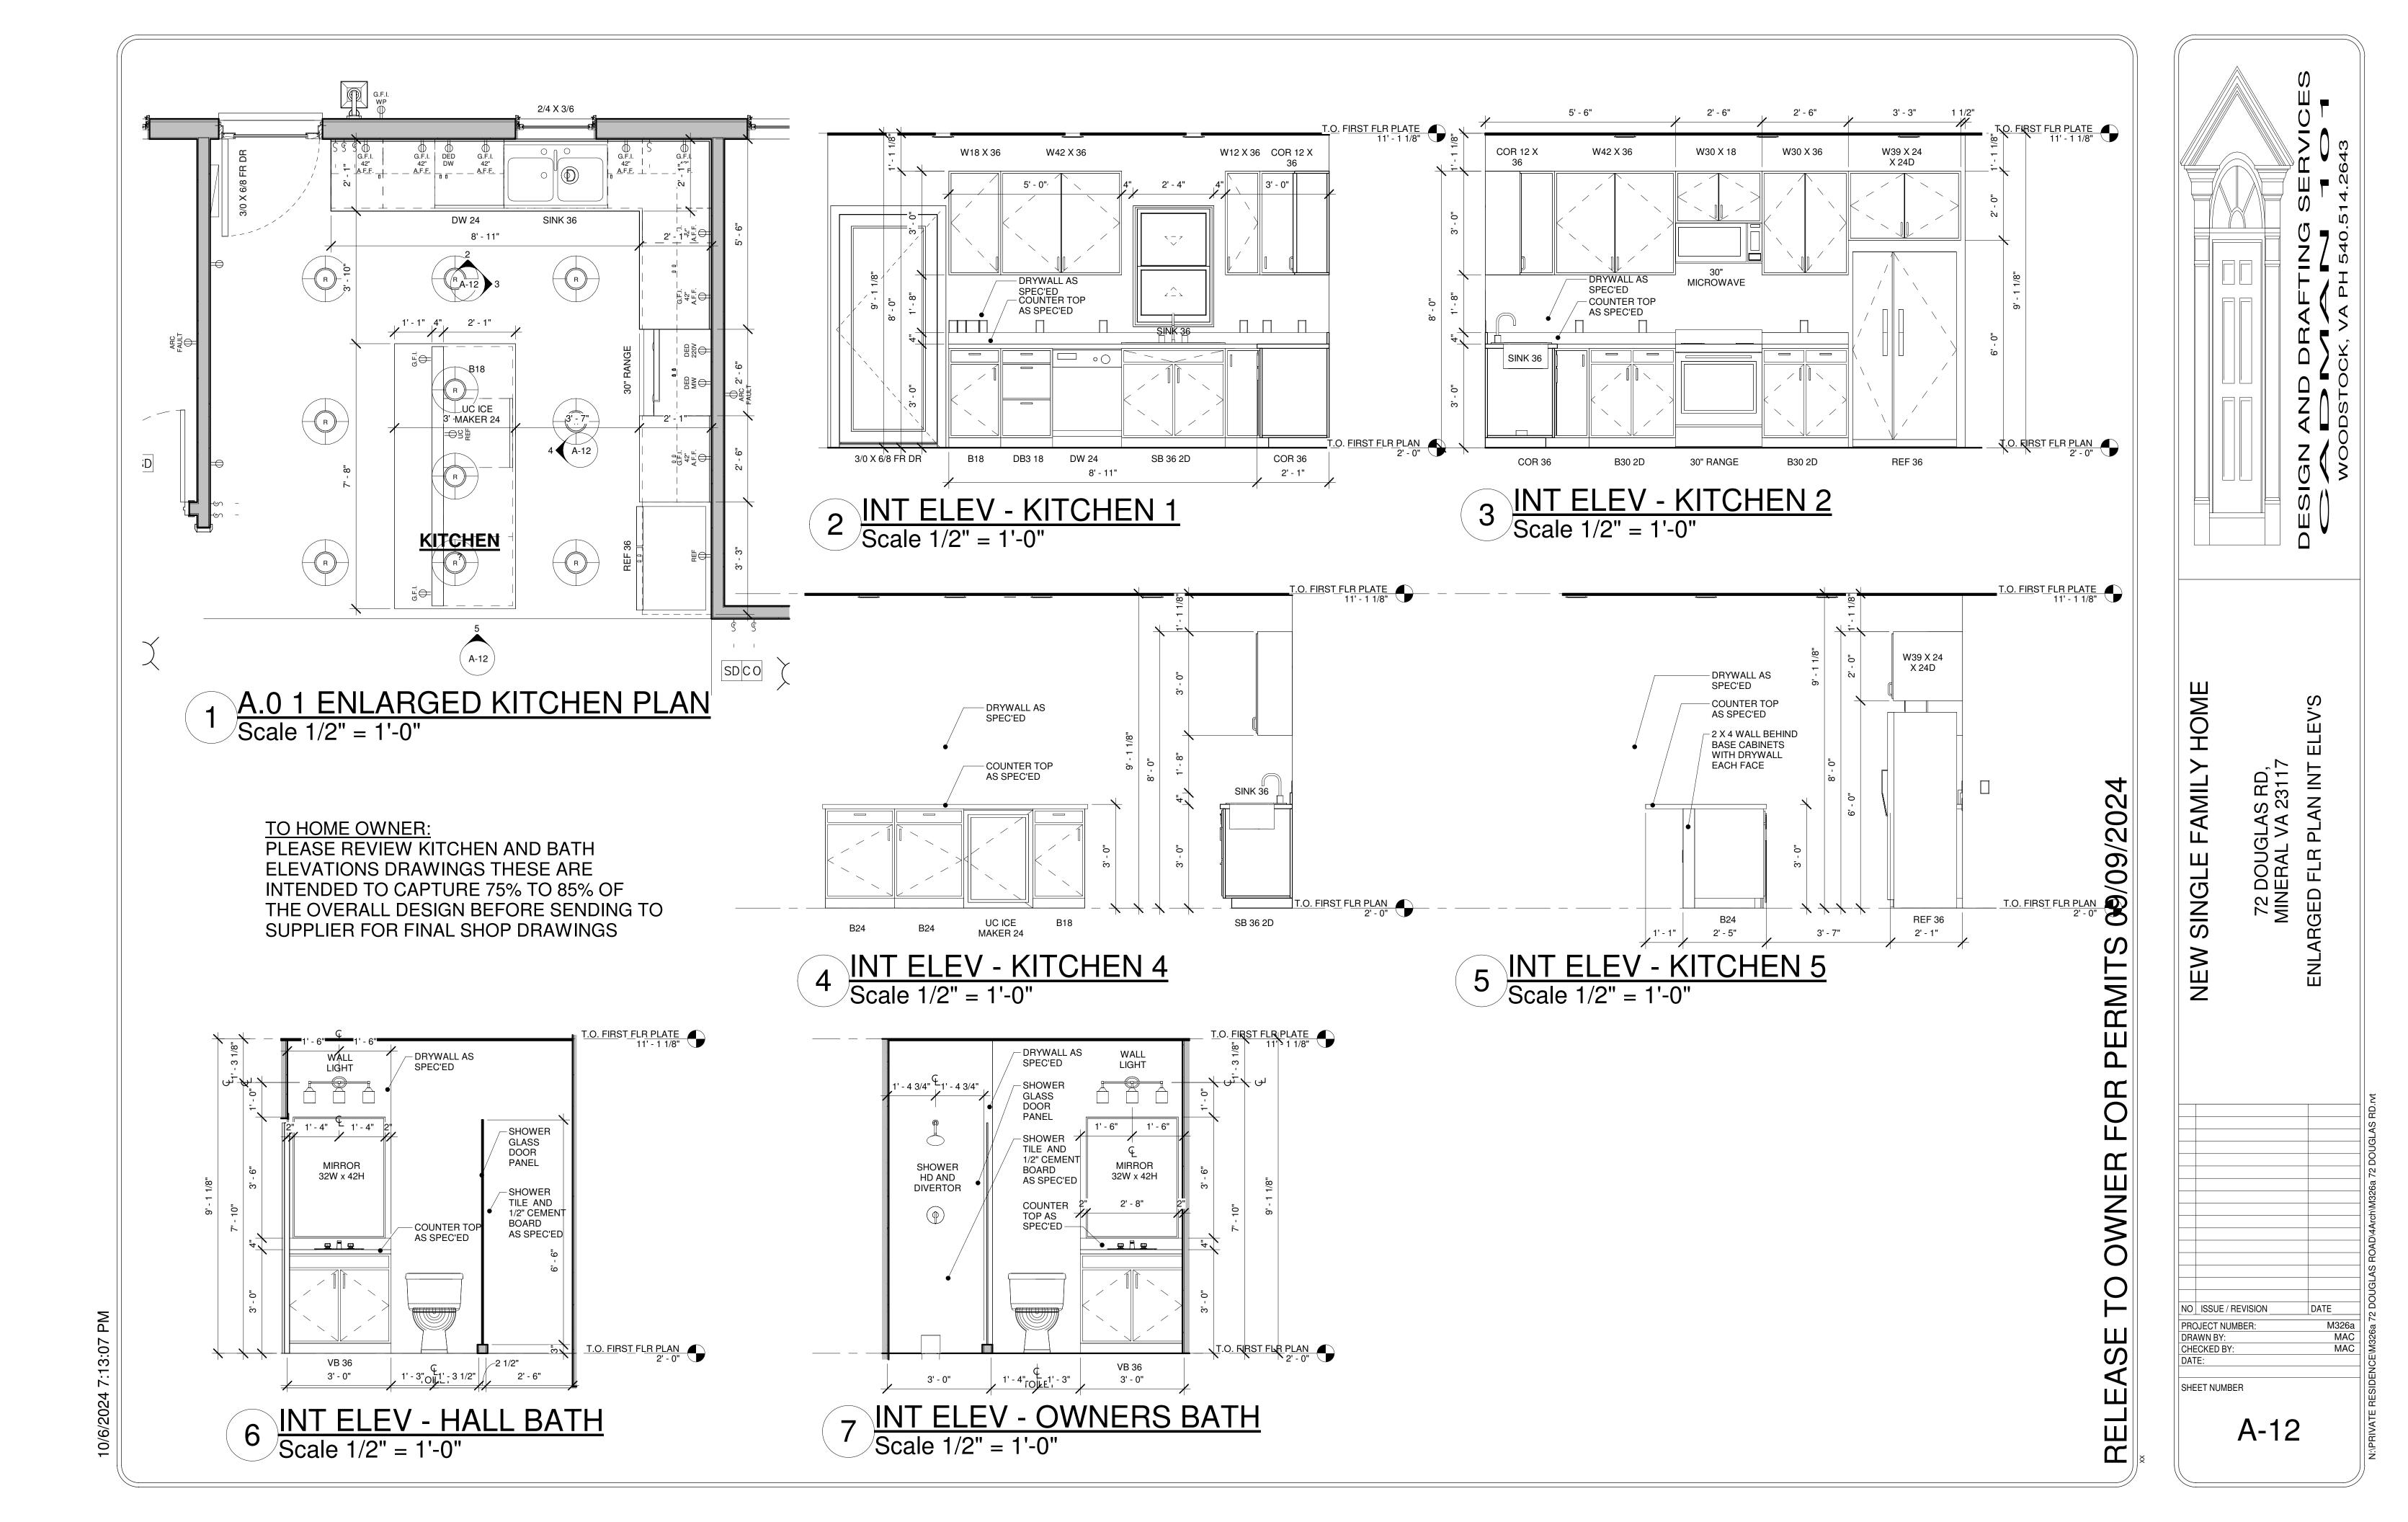
DESIGN HOME ELEVATION **FAMILY** OUGLAS RD, AL VA 23117 SIDE SINGLE 72 DOI MINER/ LEFT AND RIGH NEW NO ISSUE / REVISION SHEET NUMBER A-10

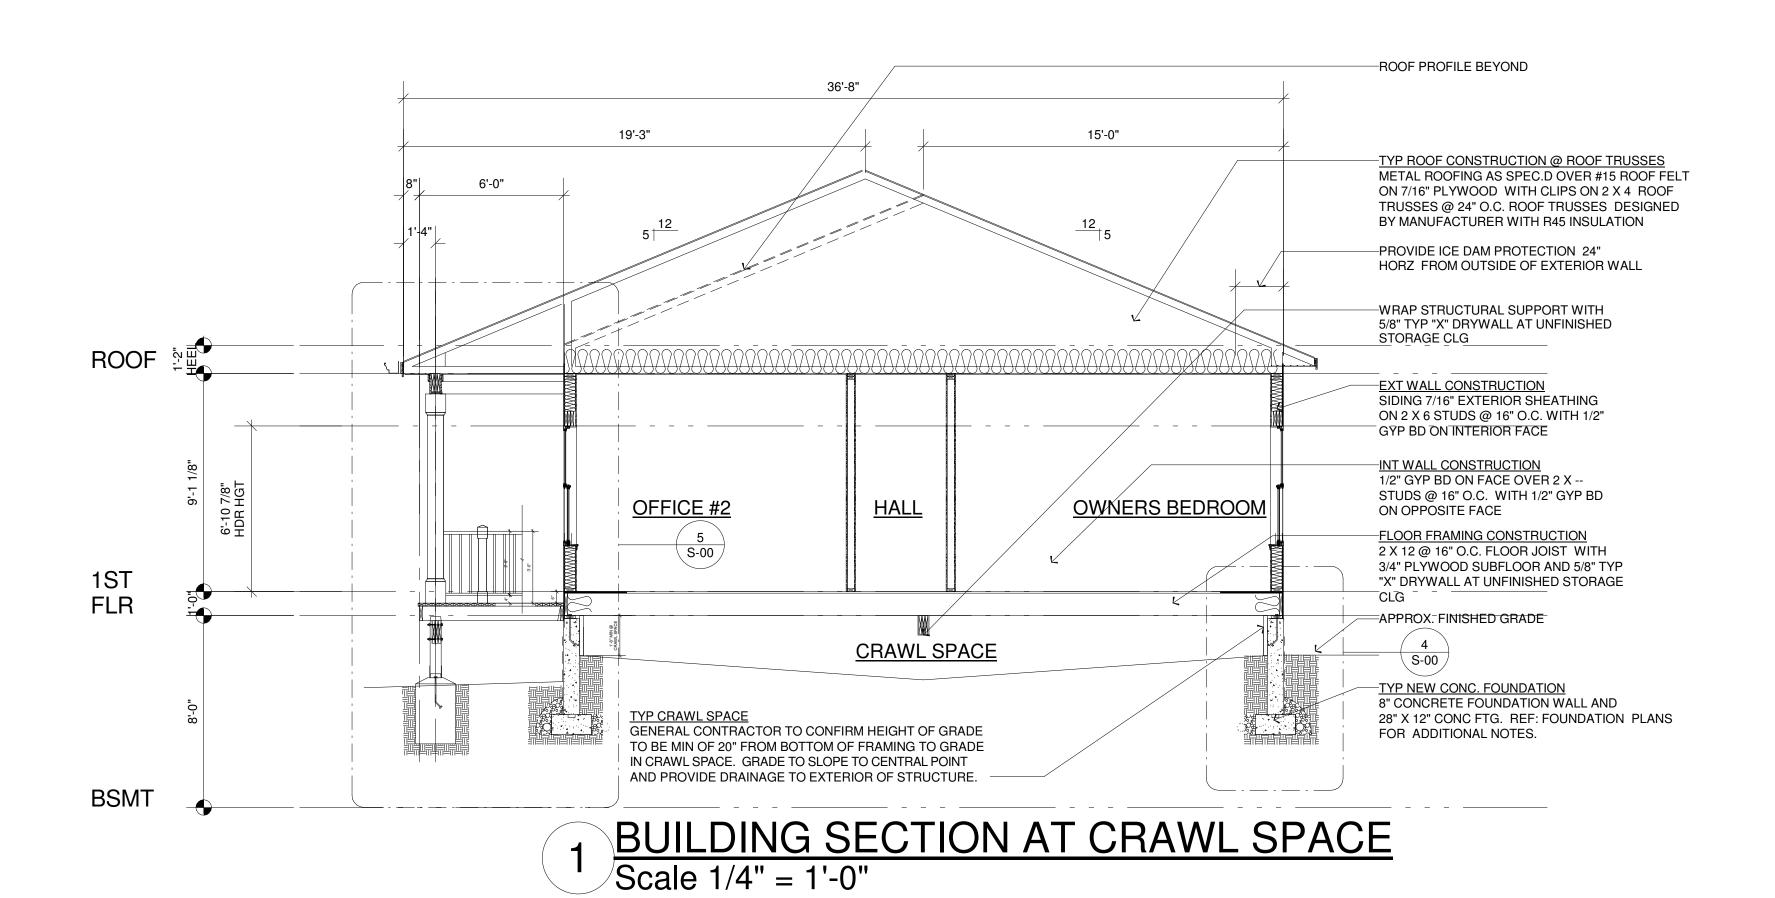
2 ELEV 04 RIGHT SIDE ELEVATION Scale 1/4" = 1'-0"

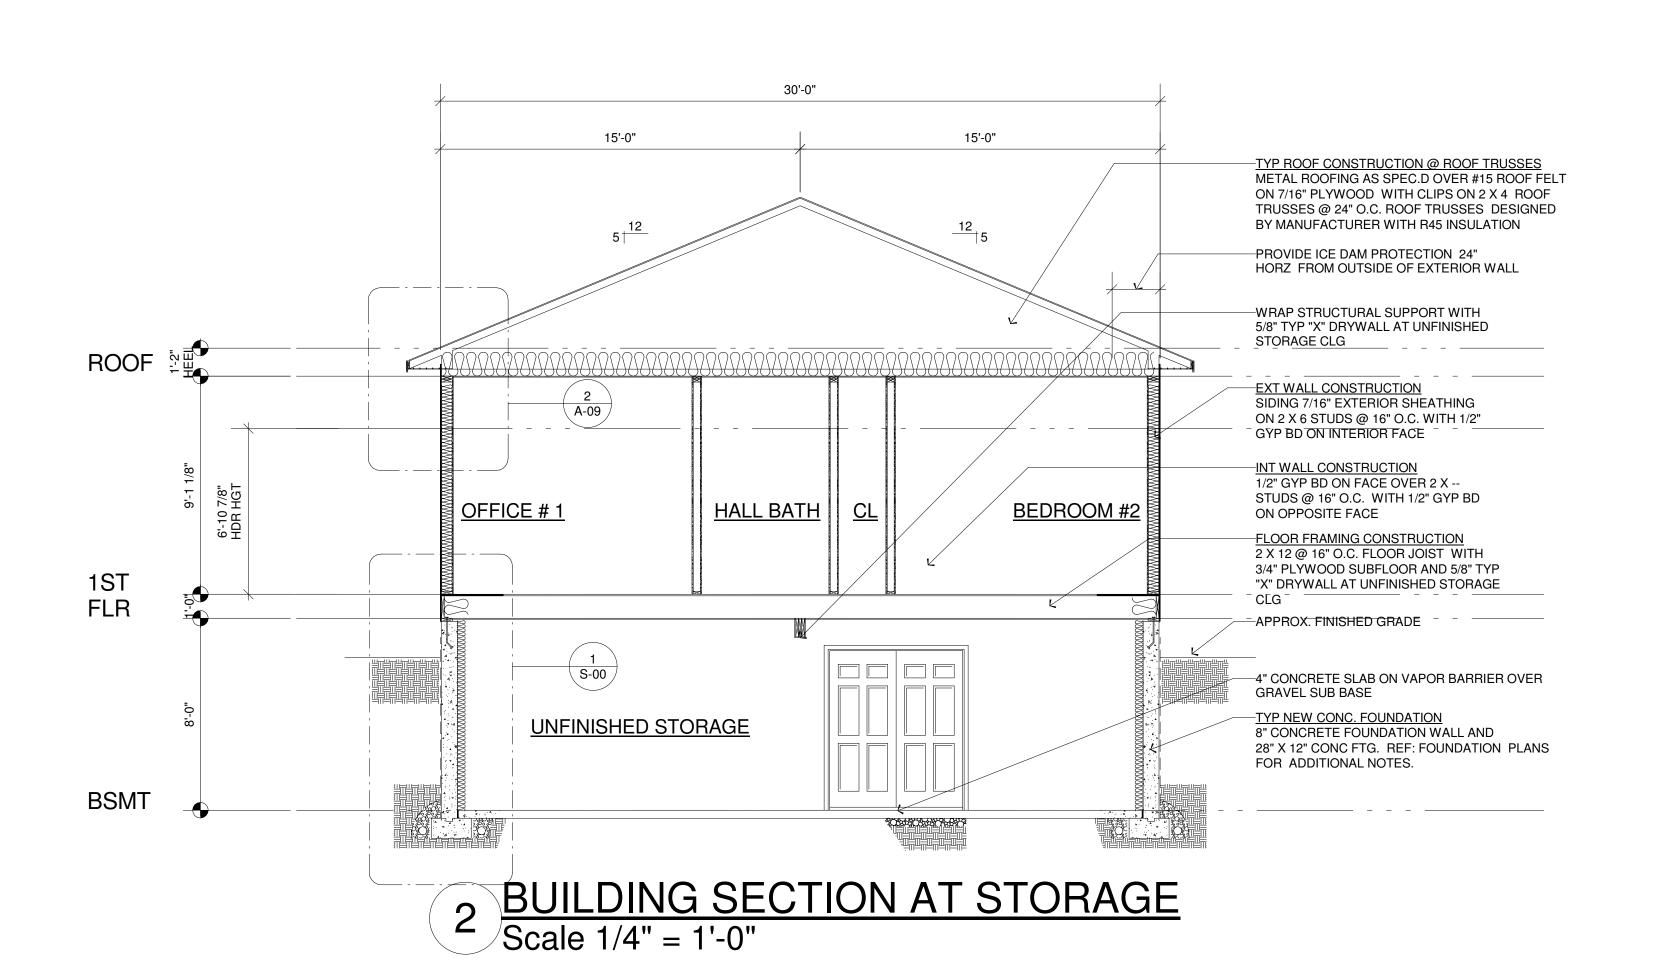




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HOME CTIONS FAMILY OUGLAS RD, AL VA 23117 72 DOU MINERA BUILDIN SINGL NO_ISSUE / REVISION CHECKED BY: SHEET NUMBER A-13

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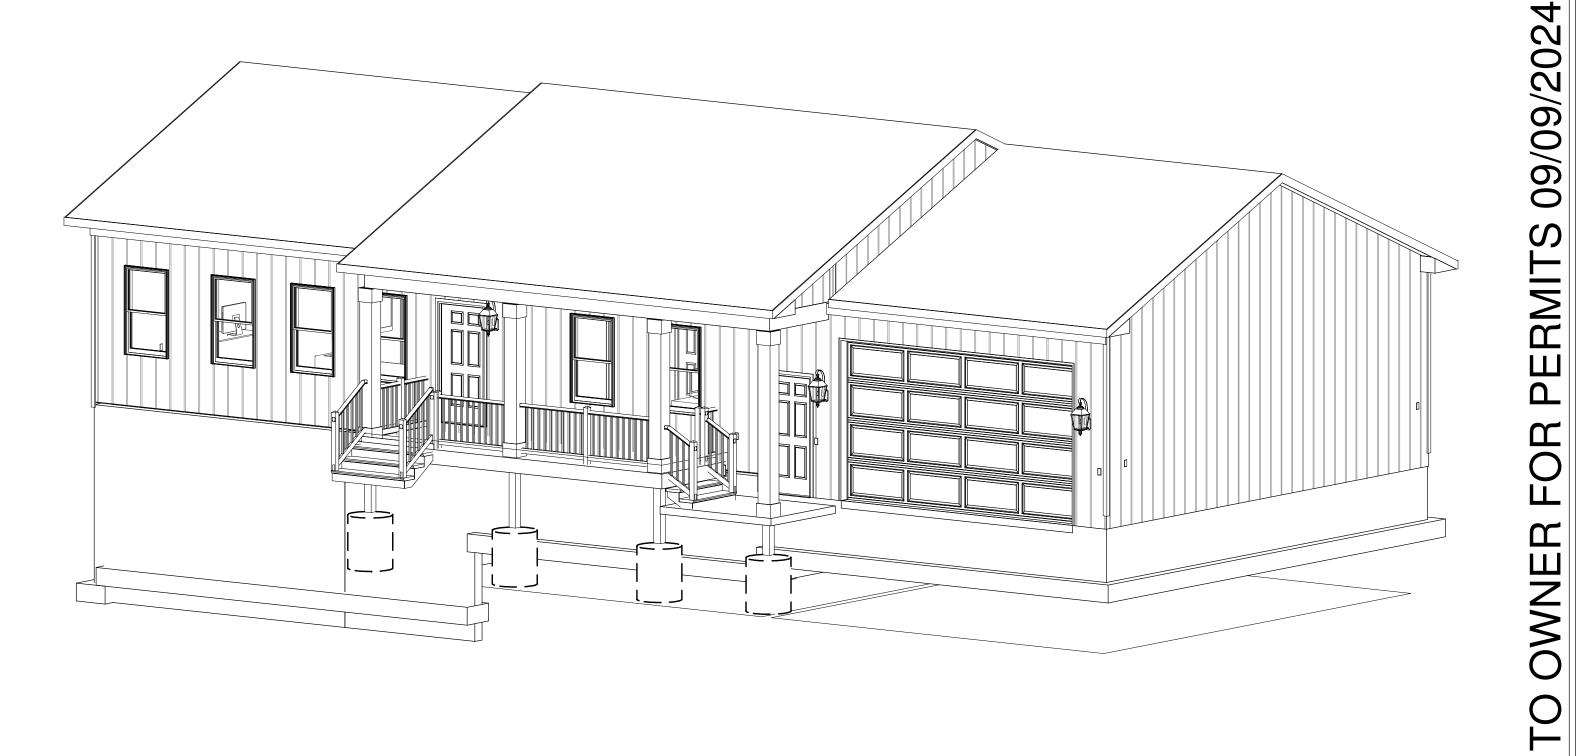
3D V INTEROR KITCHEN 1 Scale

2 3D V INTEROR KITCHEN 2 Scale

3 3D V INTEROR GREAT ROOM Scale



4 3D V EXTERIOR PORCH 1
Scale



5 3D V EXTERIOR RIGHT CORNER Scale

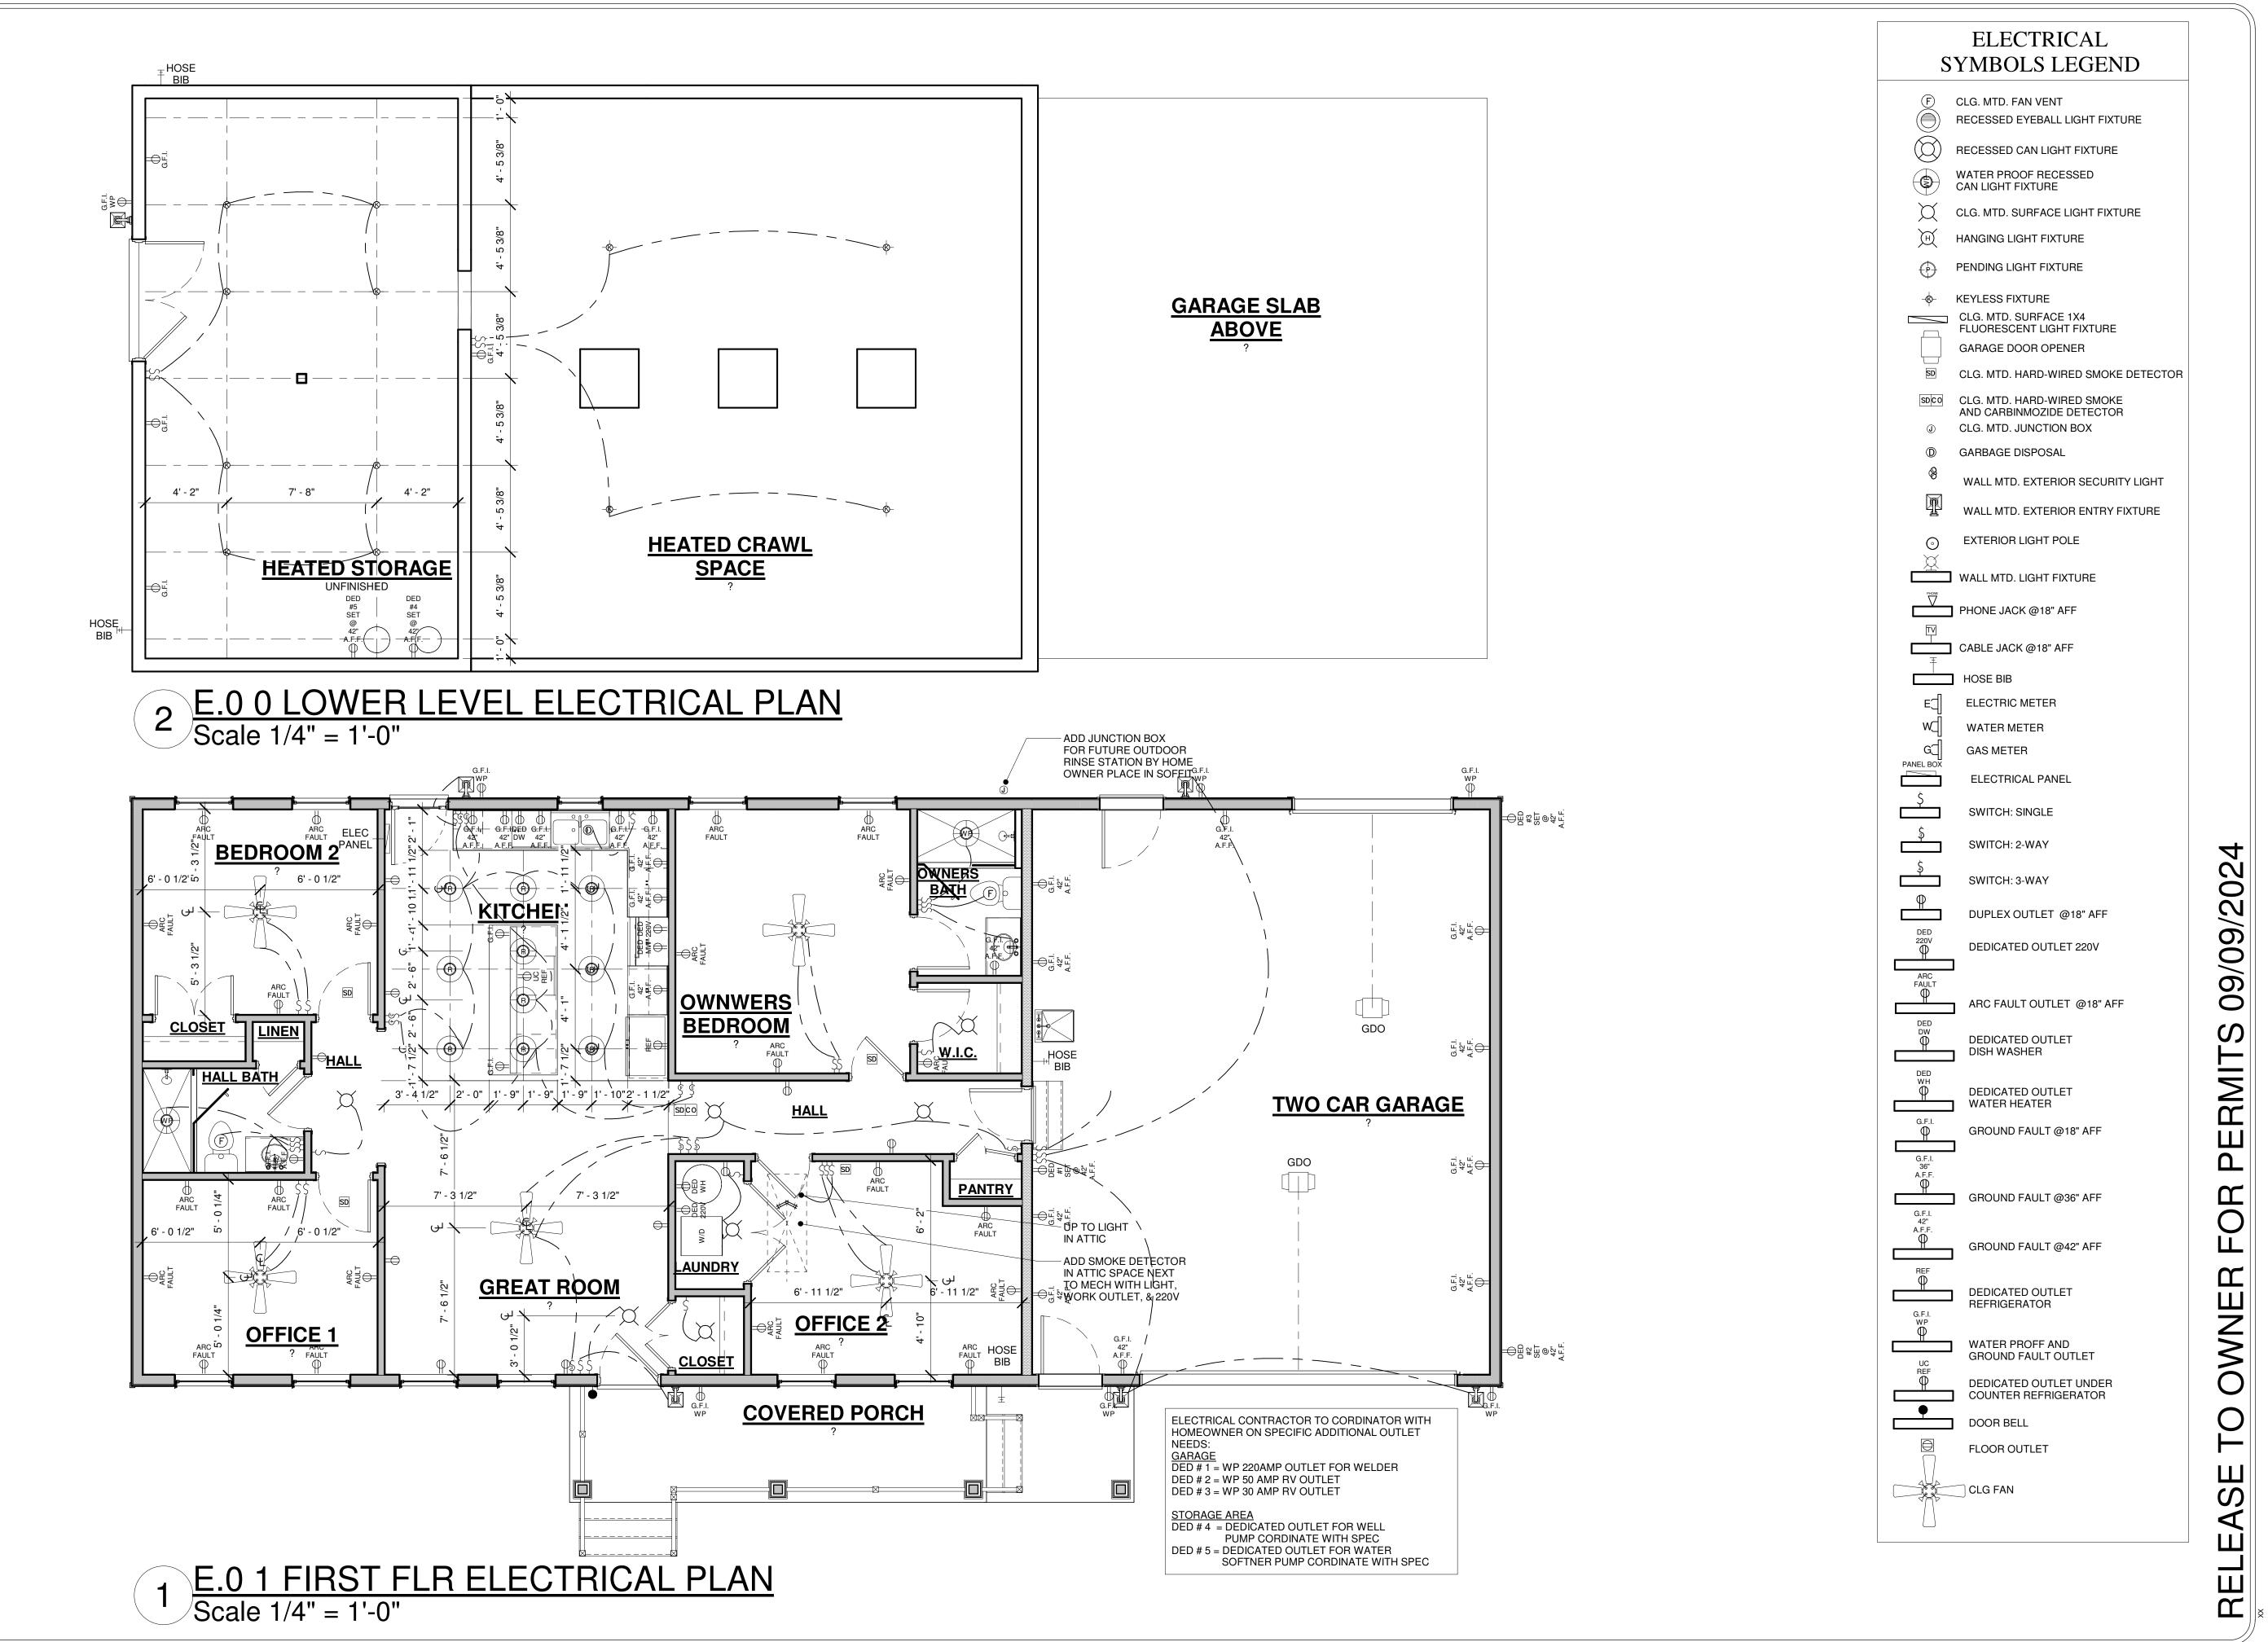
NEW SINGLE FAMILY HOME

RELEASE

72 DOUGLAS RD, MINERAL VA 23117 3D RENDERINGS / VIEWS

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ESIG HOME **FAMILY** RD, 72 DOUGLAS MINERAL VA ELECTRICAL I SINGL NO ISSUE / REVISION CHECKED BY: SHEET NUMBER E-01